


Revision Schedule		
Revision Number	Revision Description	Revision Date
2	ADDENDUM 2	02/01/2017

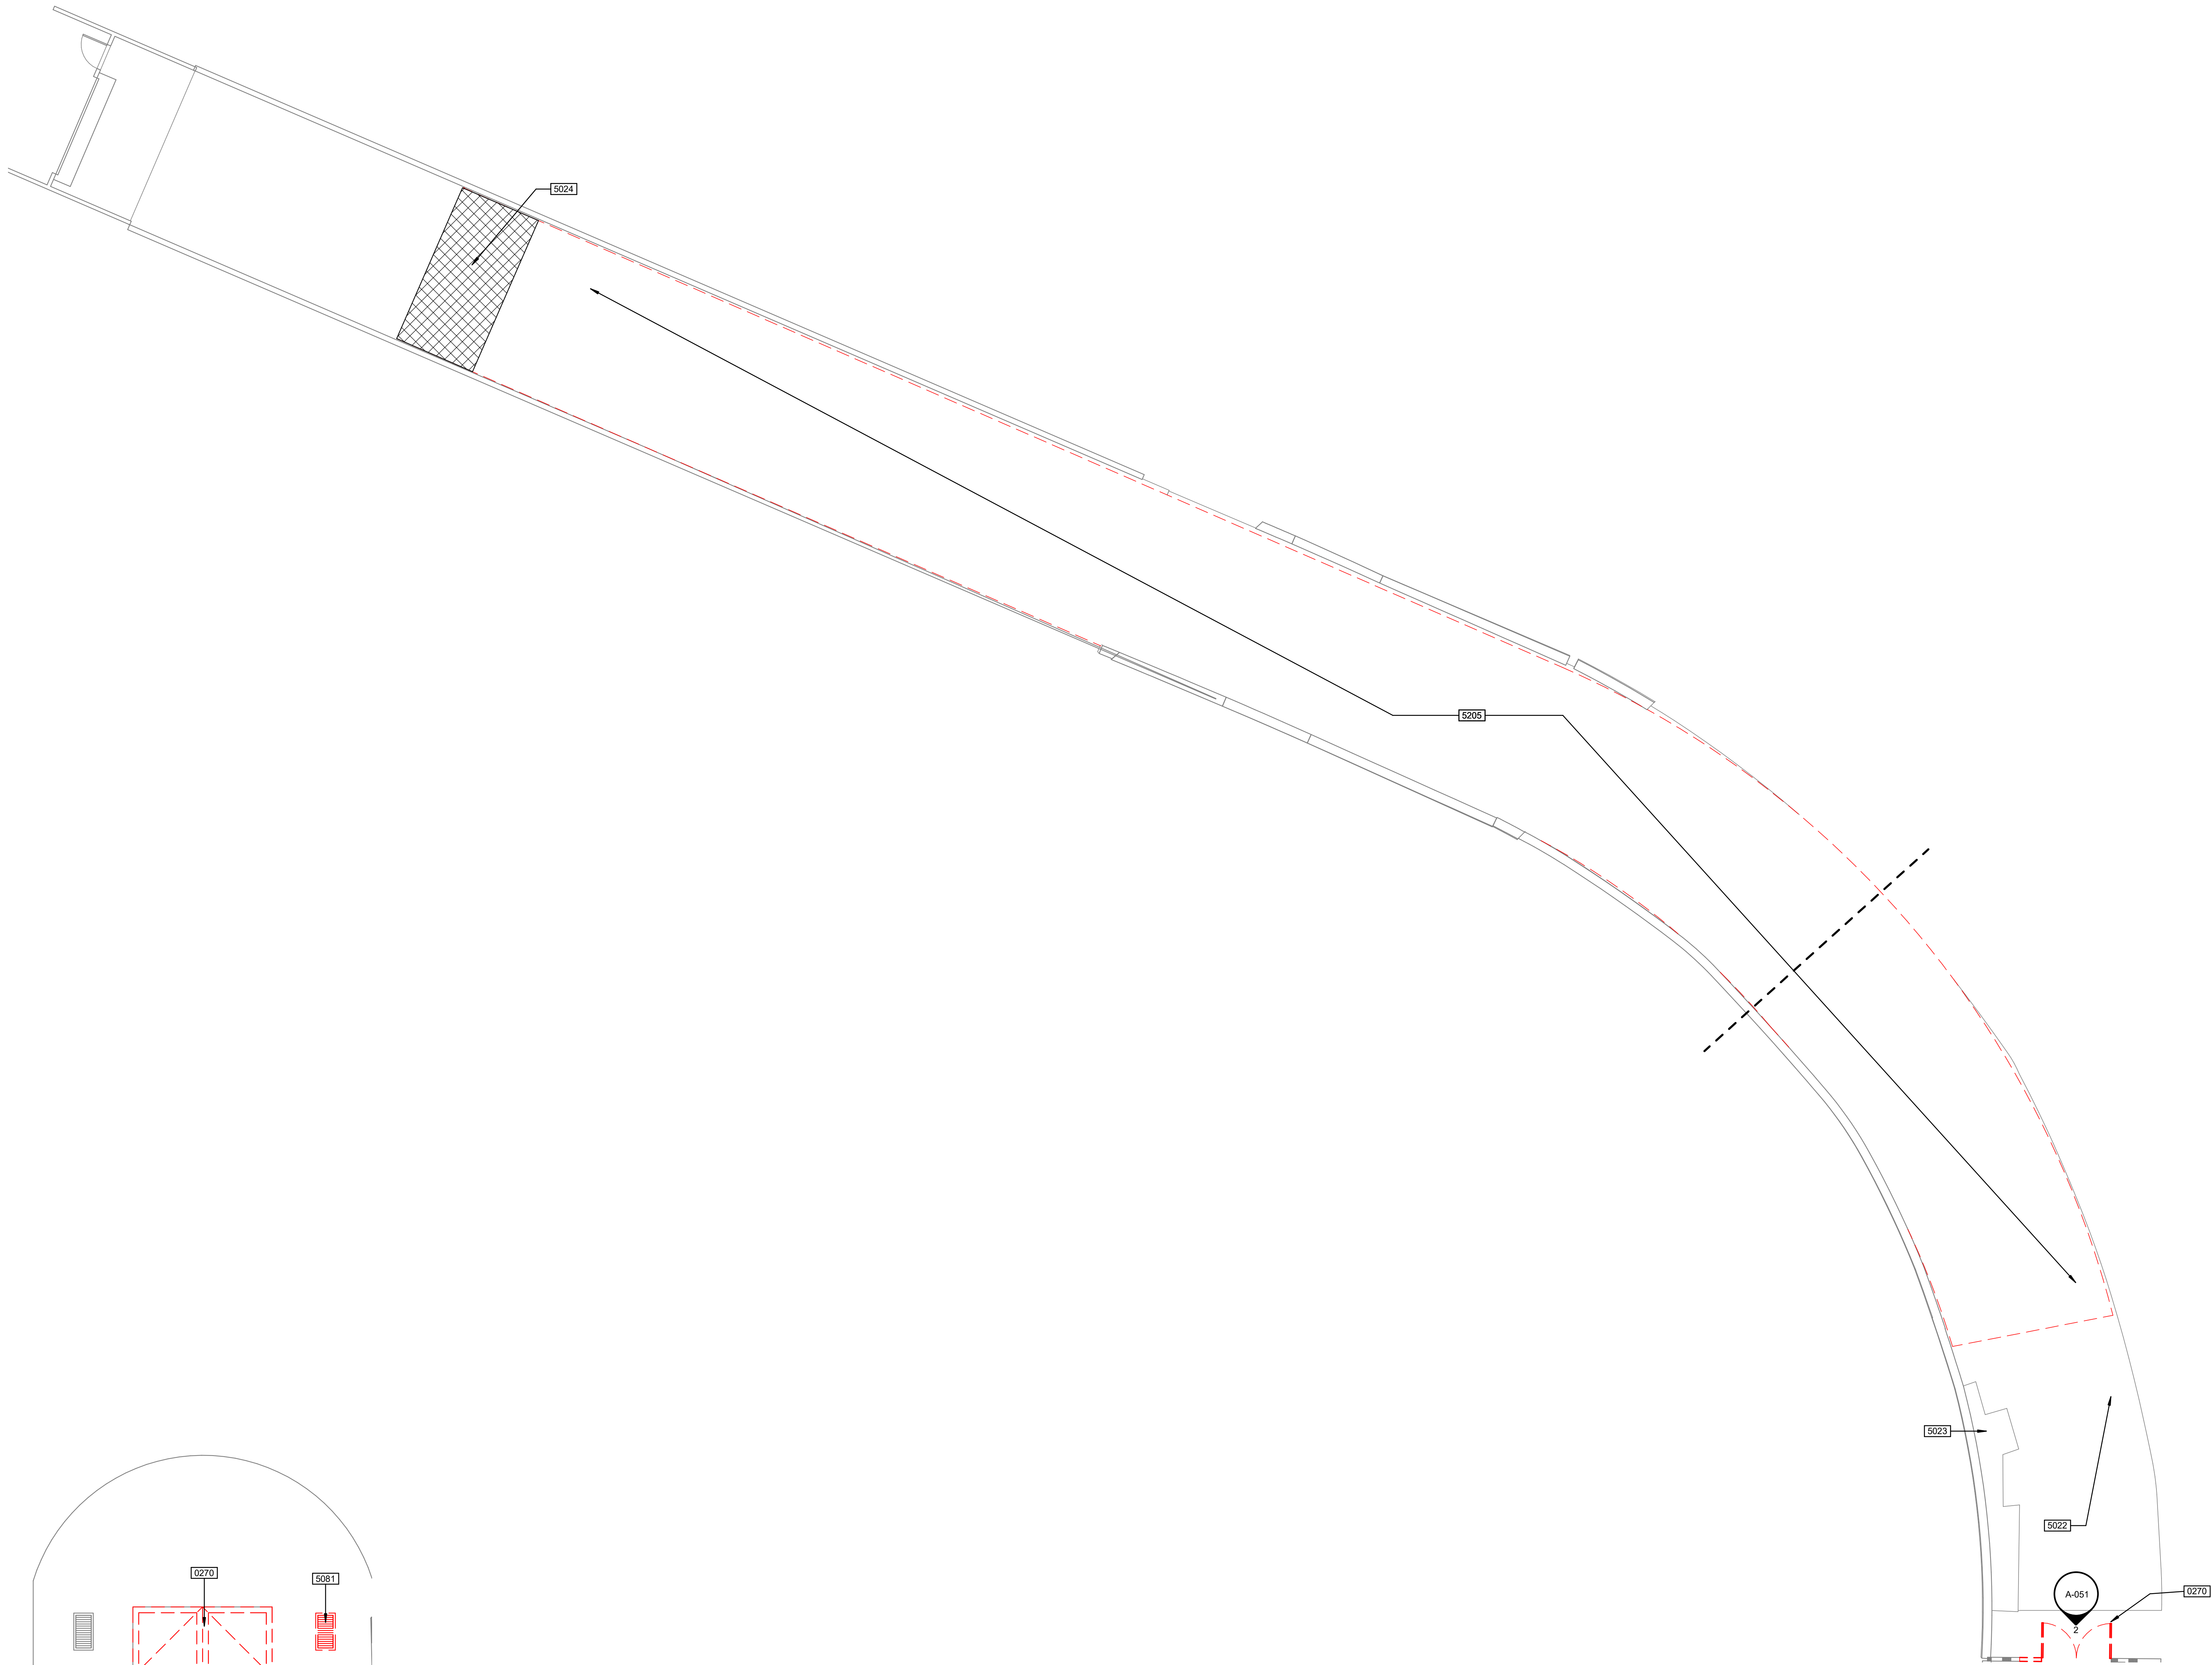

Sheet Notes:
1. Protect existing MEP equipment and artwork that is to remain within the tunnel throughout the course of construction.
2. Refer to MEPS drawings for additional demolition scope not shown herein.

Keynote Legend Sheet	
Key Value	Keynote Text
0270	(E) DOOR, SALVAGE, REINSTALL
5022	REMOVE EPOXY PAINTED FLOOR FINISH OVER EXISTING CONCRETE SLAB ON GRADE AND PREPARE SURFACE AS REQUIRED TO ACCOMMODATE GRINDING AND POLISHING OF CONCRETE SURFACE AS SPECIFIED AND INDICATED UNDER NEW WORK SCOPE
5023	EXISTING HOUSEKEEPING PAD AND EQUIPMENT TO REMAIN
5024	CHIPPING DEPTH TO VARY UP TO 3 1/2" S.S.D
5081	(E) ELECTRIFIED SMOKE CONTROL DAMPER
5205	SURFACE SCABBING PER STRUCTURAL DRAWINGS

2 Elevation 4 - a
1/4" = 1'-0"

1 DEMO FEH
1/8" = 1'-0"

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J

W

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F


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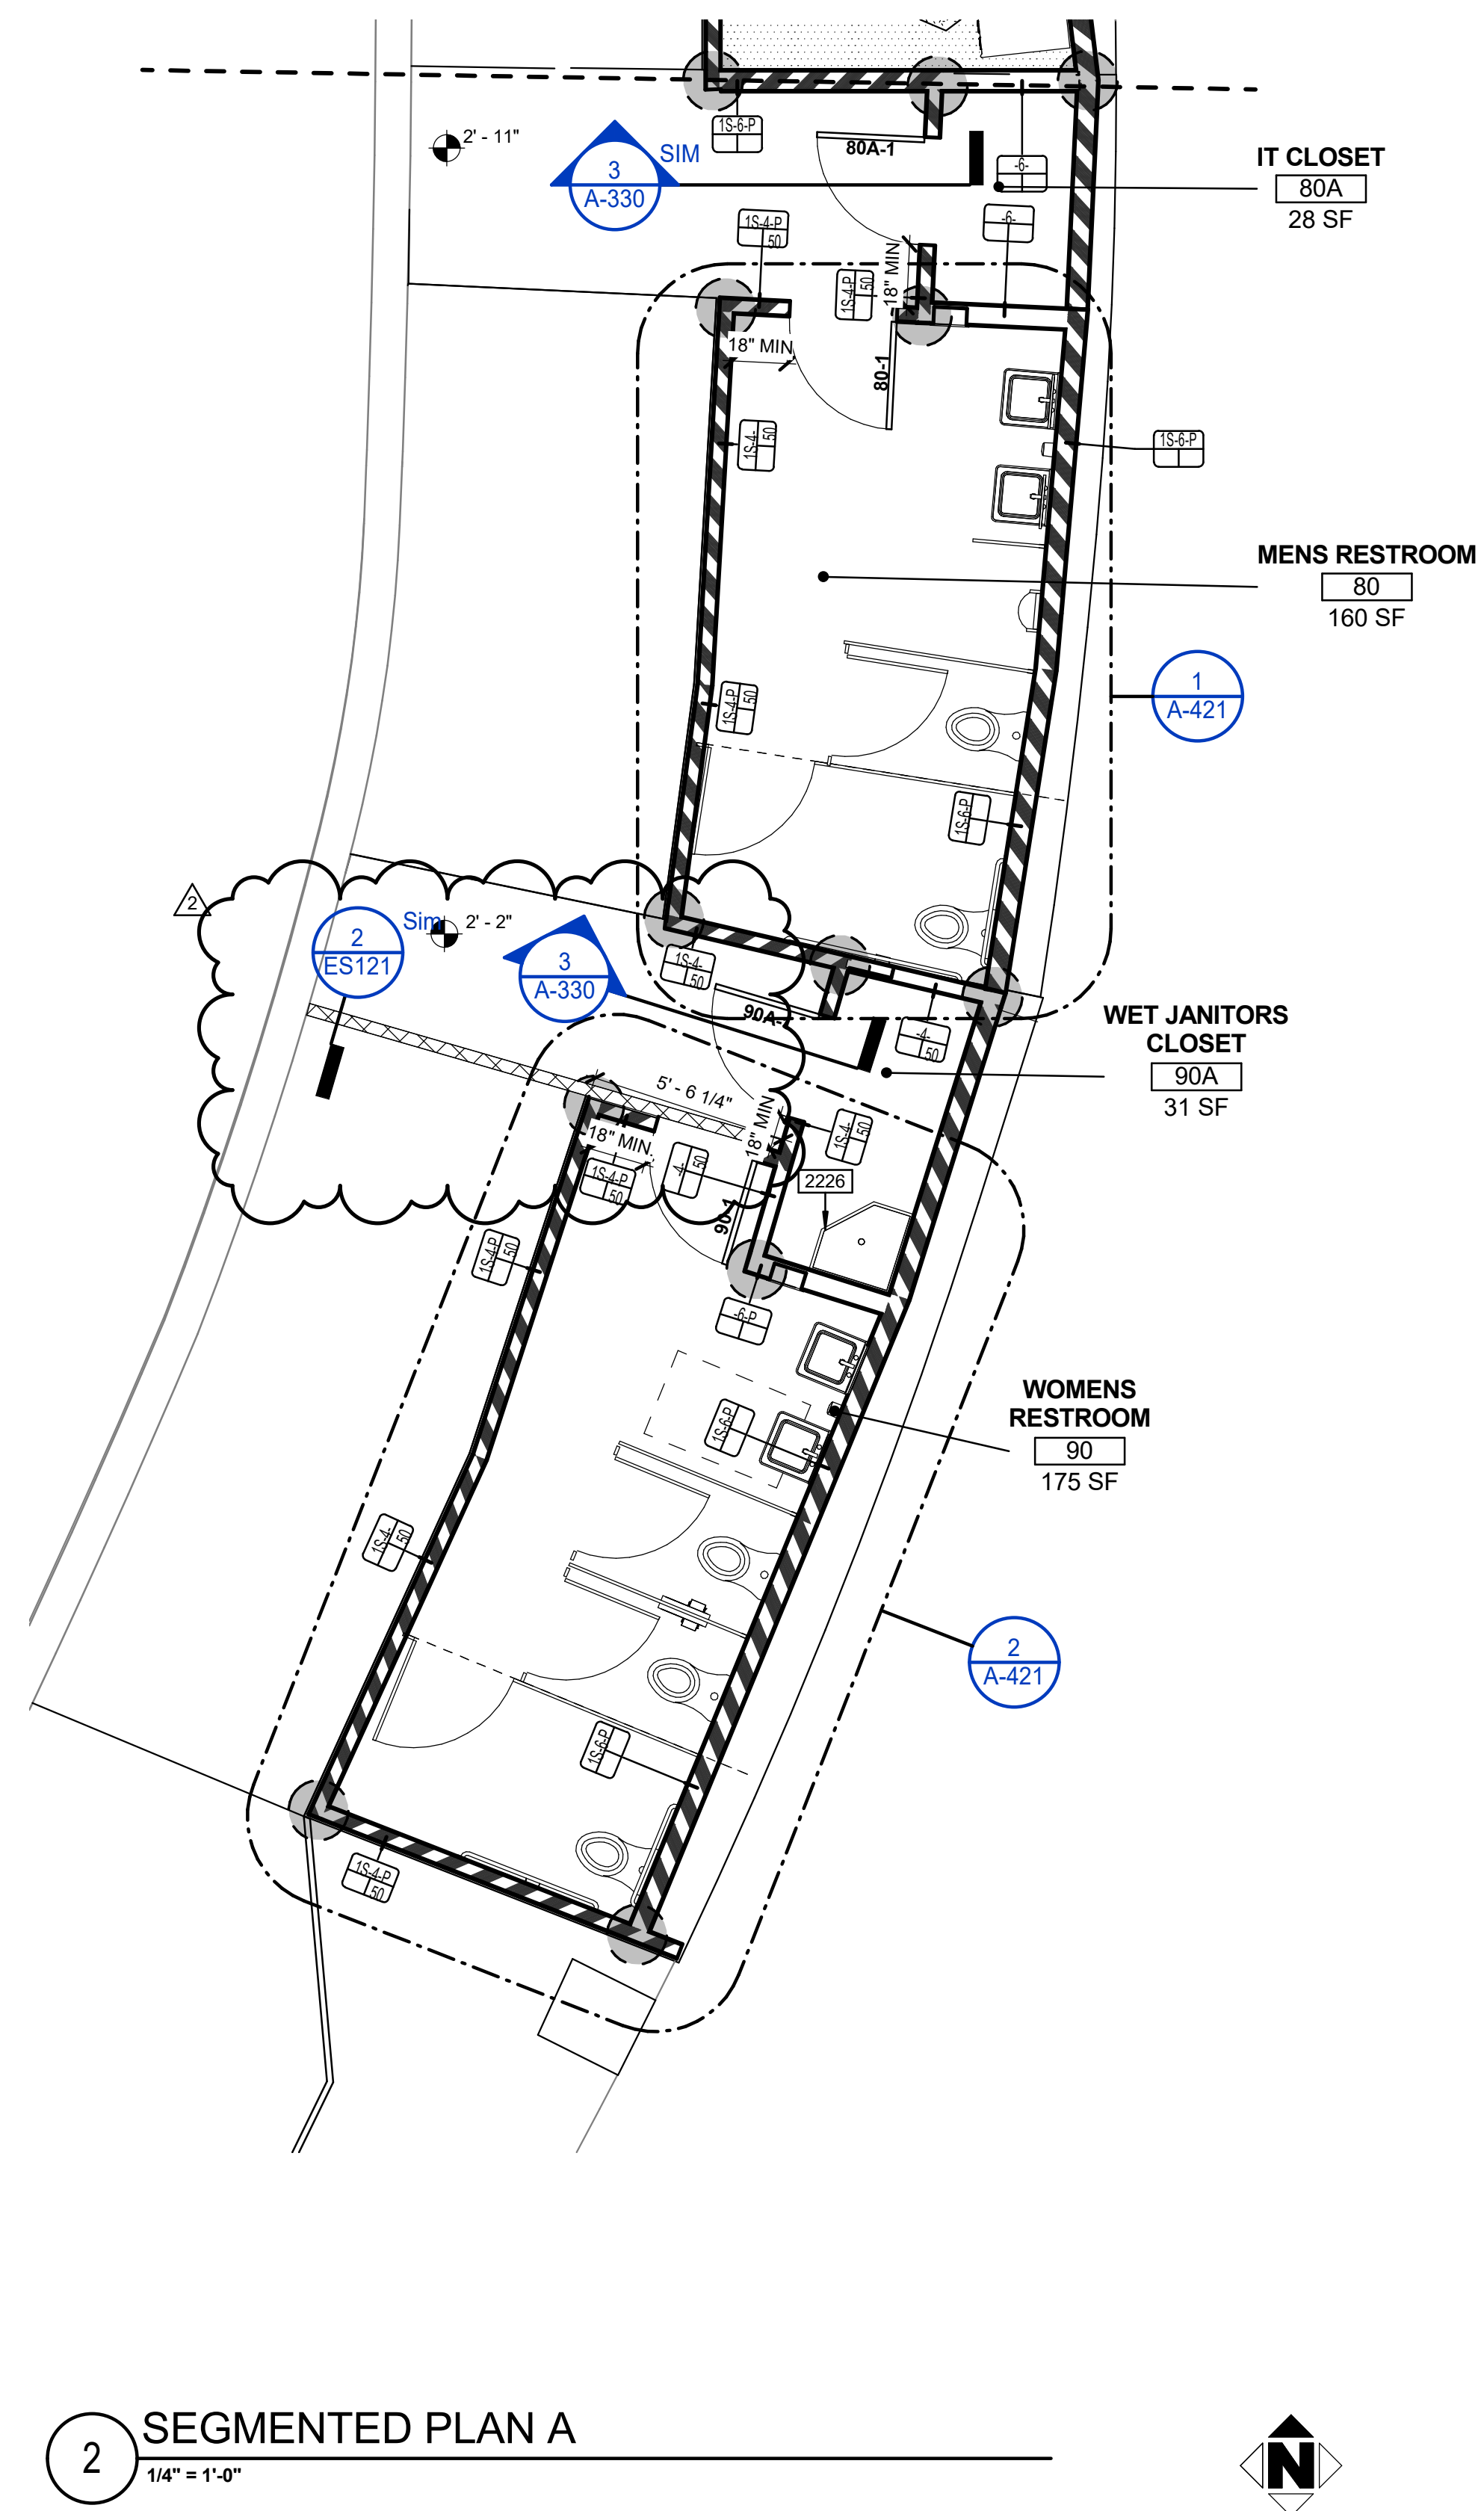
REGISTERED ARCHITECT
FRANK J. WILLIAMS
NO. C-2033
EXPI. 12-31-17
STATE OF CALIFORNIA

SCALE: As indicated	DO NOT SCALE DRAWING	B999A001-0013.dwg	A-051	1 of 1
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ENGR DES Designer CHKR Checker		DATE 02/01/2017 02/01/2017	APPROVALS DATE 01/06/2017	DRAWING NUMBER B999A001-0013
REVISION A0				E

Revision Schedule		
Revision Number	Revision Description	Revision Date
2	ADDENDUM 2	02/01/2017



1
1/4" = 1'-0"

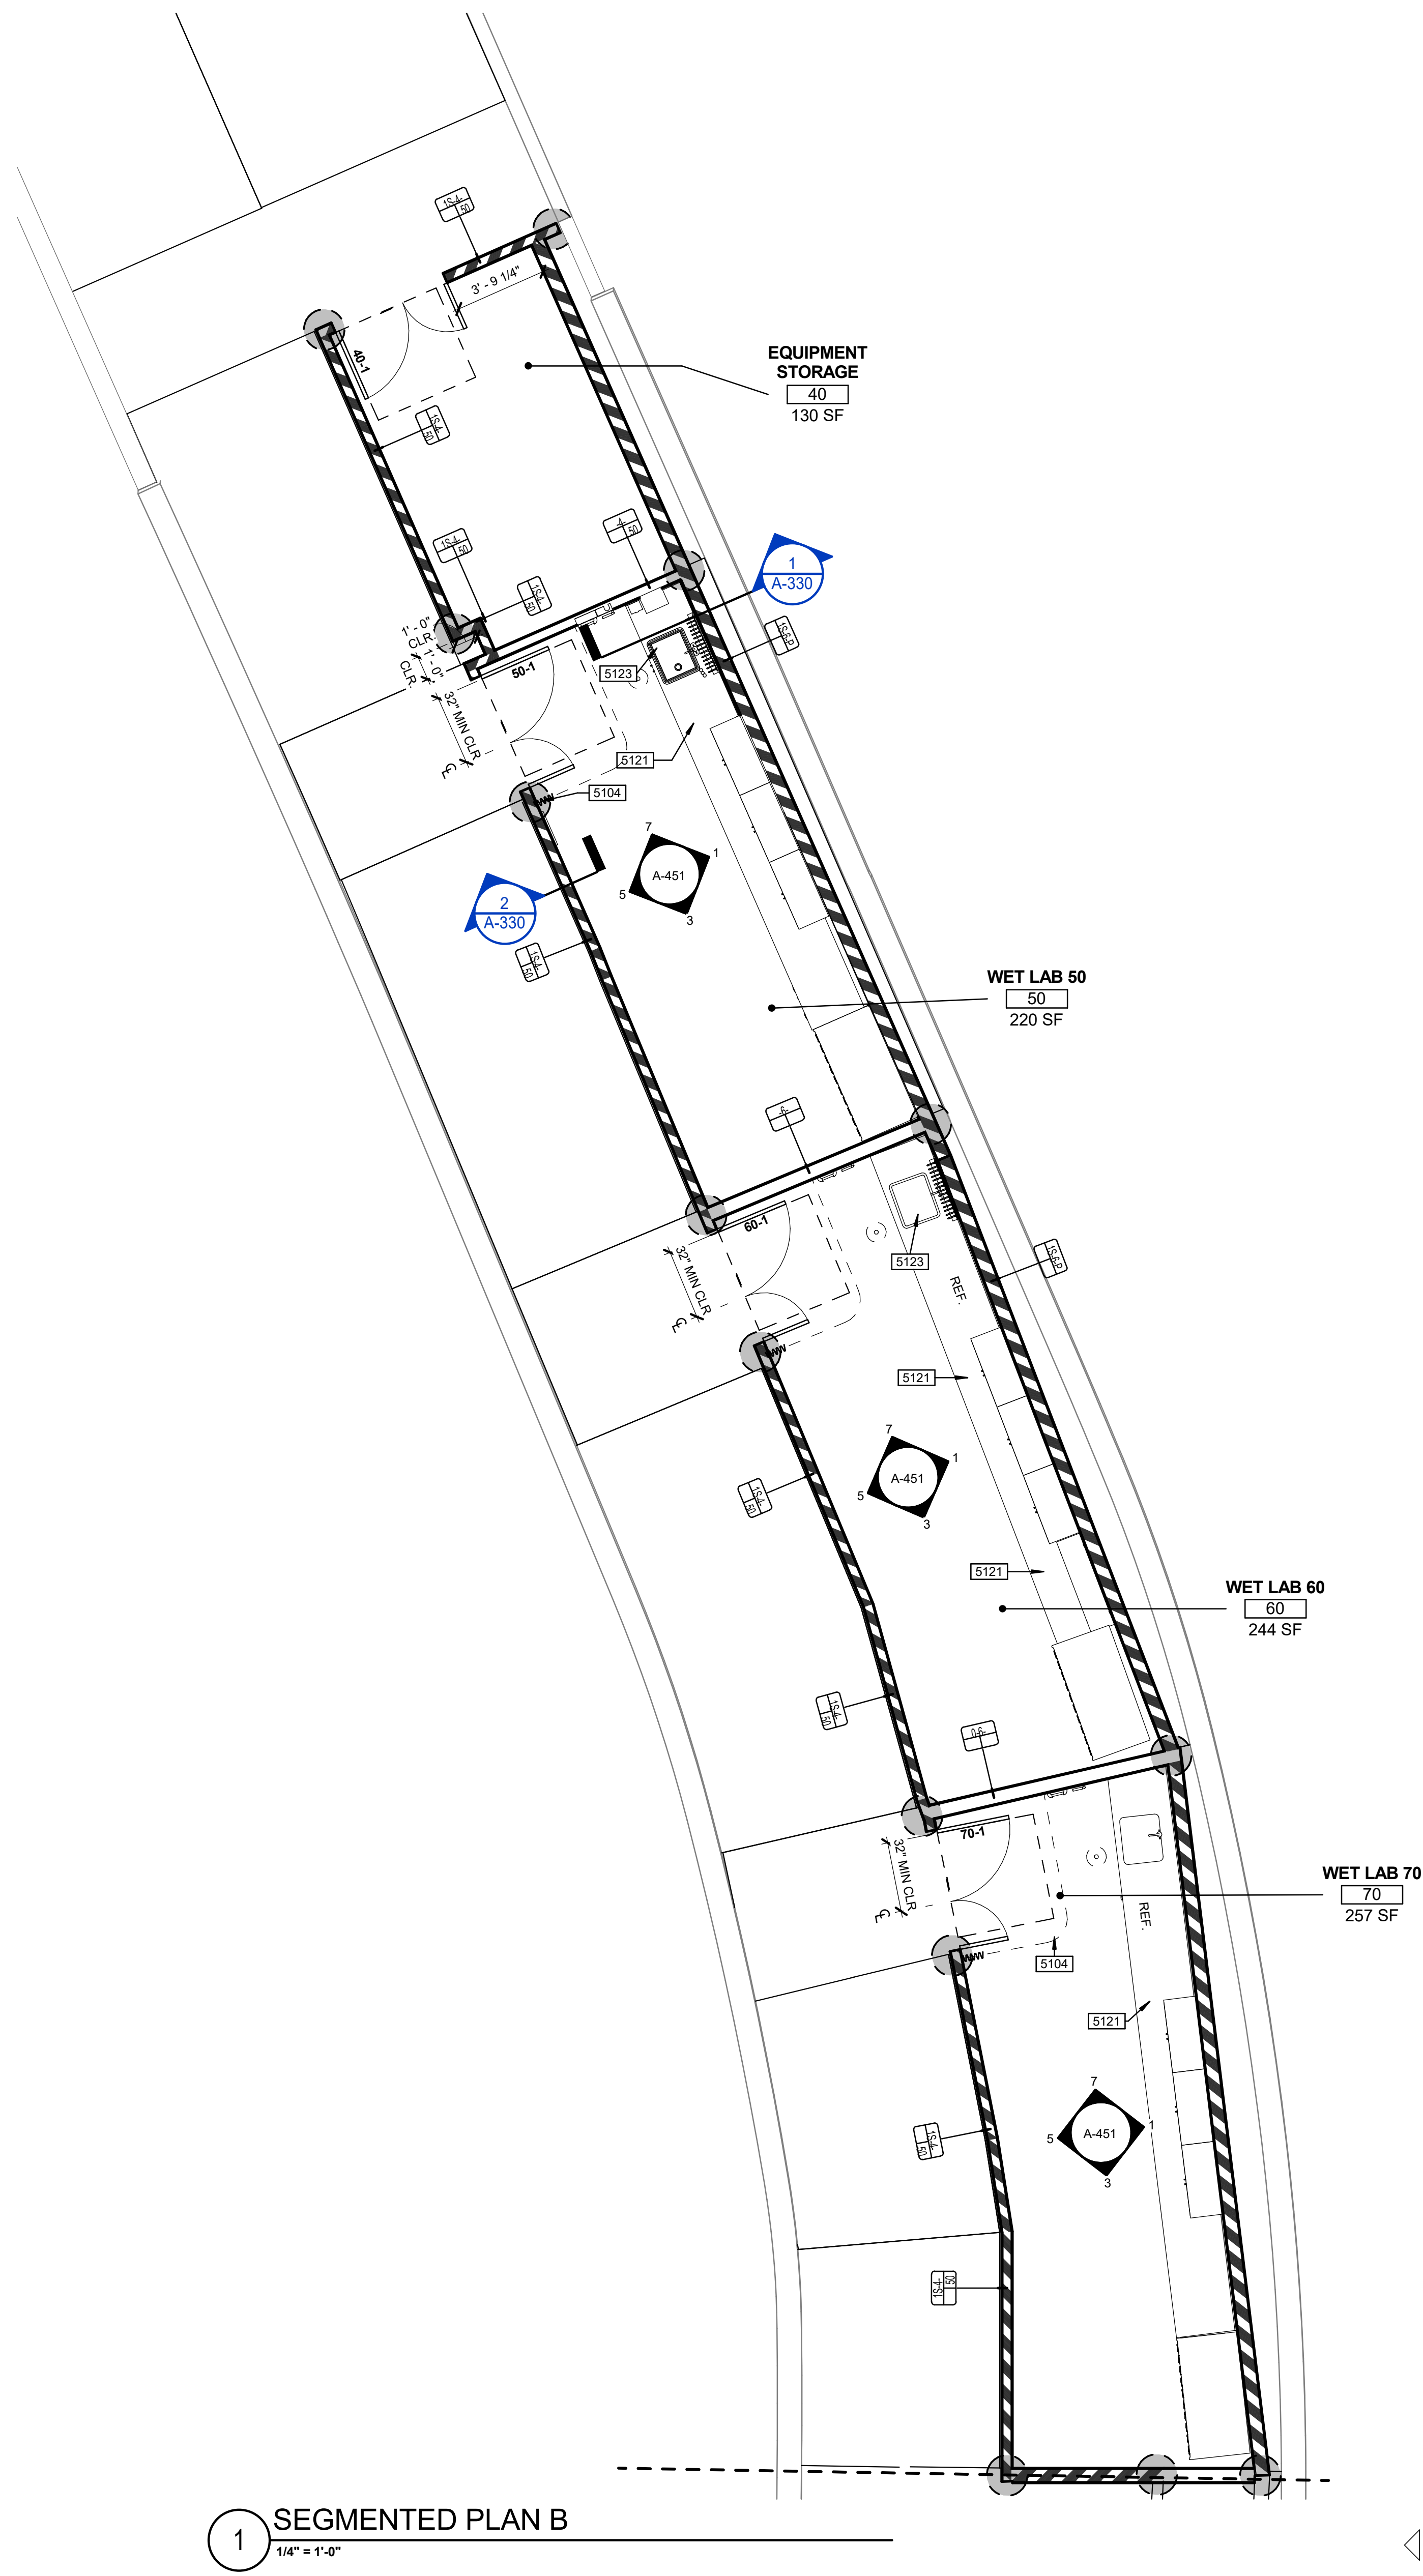


2
1/4" = 1'-0"

Keynote Legend Sheet	
Key Value	Keynote Text
2226	FLOOR SINK
S104	BLACKOUT CURTAIN
S121	EPOXY COUNTERTOP
S123	EPOXY SINK

PLAN LEGEND	
	SIMPSON SLTT20 HOLD-DOWN W/ 3/8" DIAM. HILTI HUS-EZ CONCRETE SCREWS W/ 1/8" EMBED. PER ICC ESR-3027
	(22) LOCATIONS TOTAL
	(1) 1/2" x 1 1/2" x 5/16" SQUARE PLATE WASHERS TYP.
	CONN. BACK TO BACK WALL STUDS TO EACH OTHER WITH #10 SMS @ 12" O.C. STAGGERED, TYP.
	(22) LOCATIONS TOTAL

Revision Schedule		
Revision Number	Revision Description	Revision Date
2	ADDENDUM 2	02/01/2017

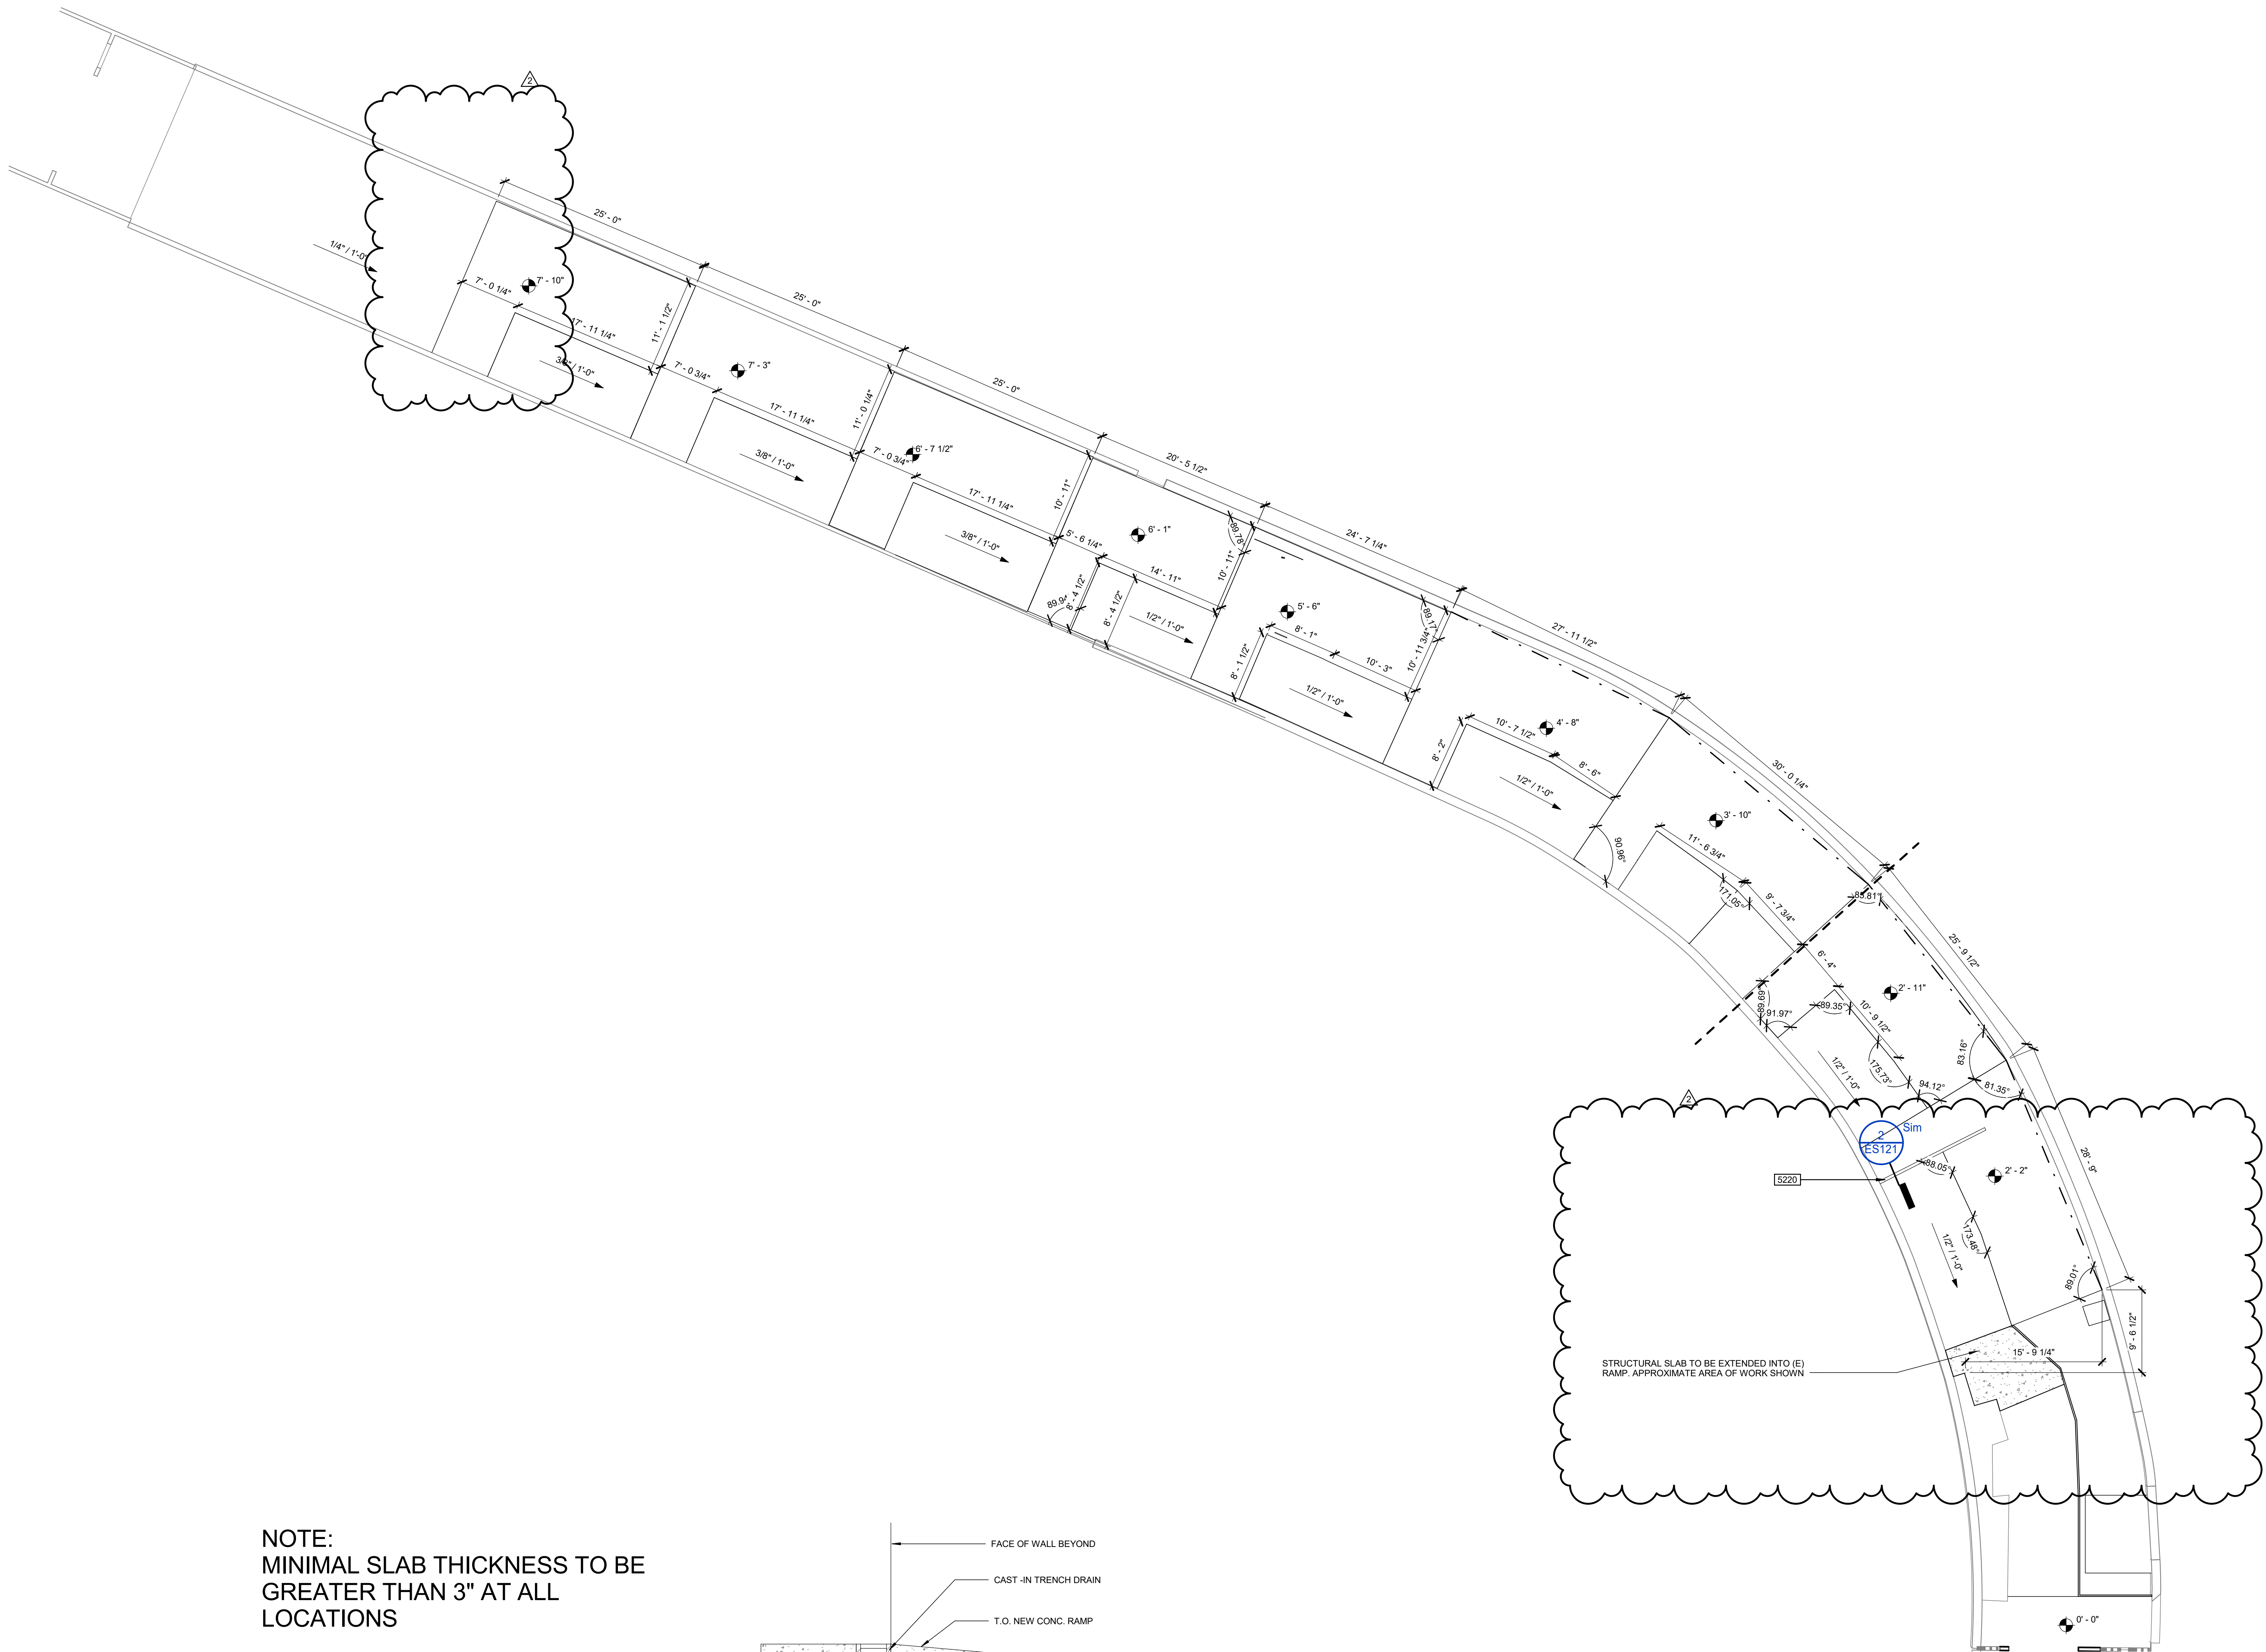

Keynote Legend Sheet	
Key Value	Keynote Text
6220	CAST-IN TRENCH DRAIN


1 EDGE OF SLAB PLAN
1/8" = 1'-0"

2 TRENCH DRAIN DETAIL
1 1/2" = 1'-0"

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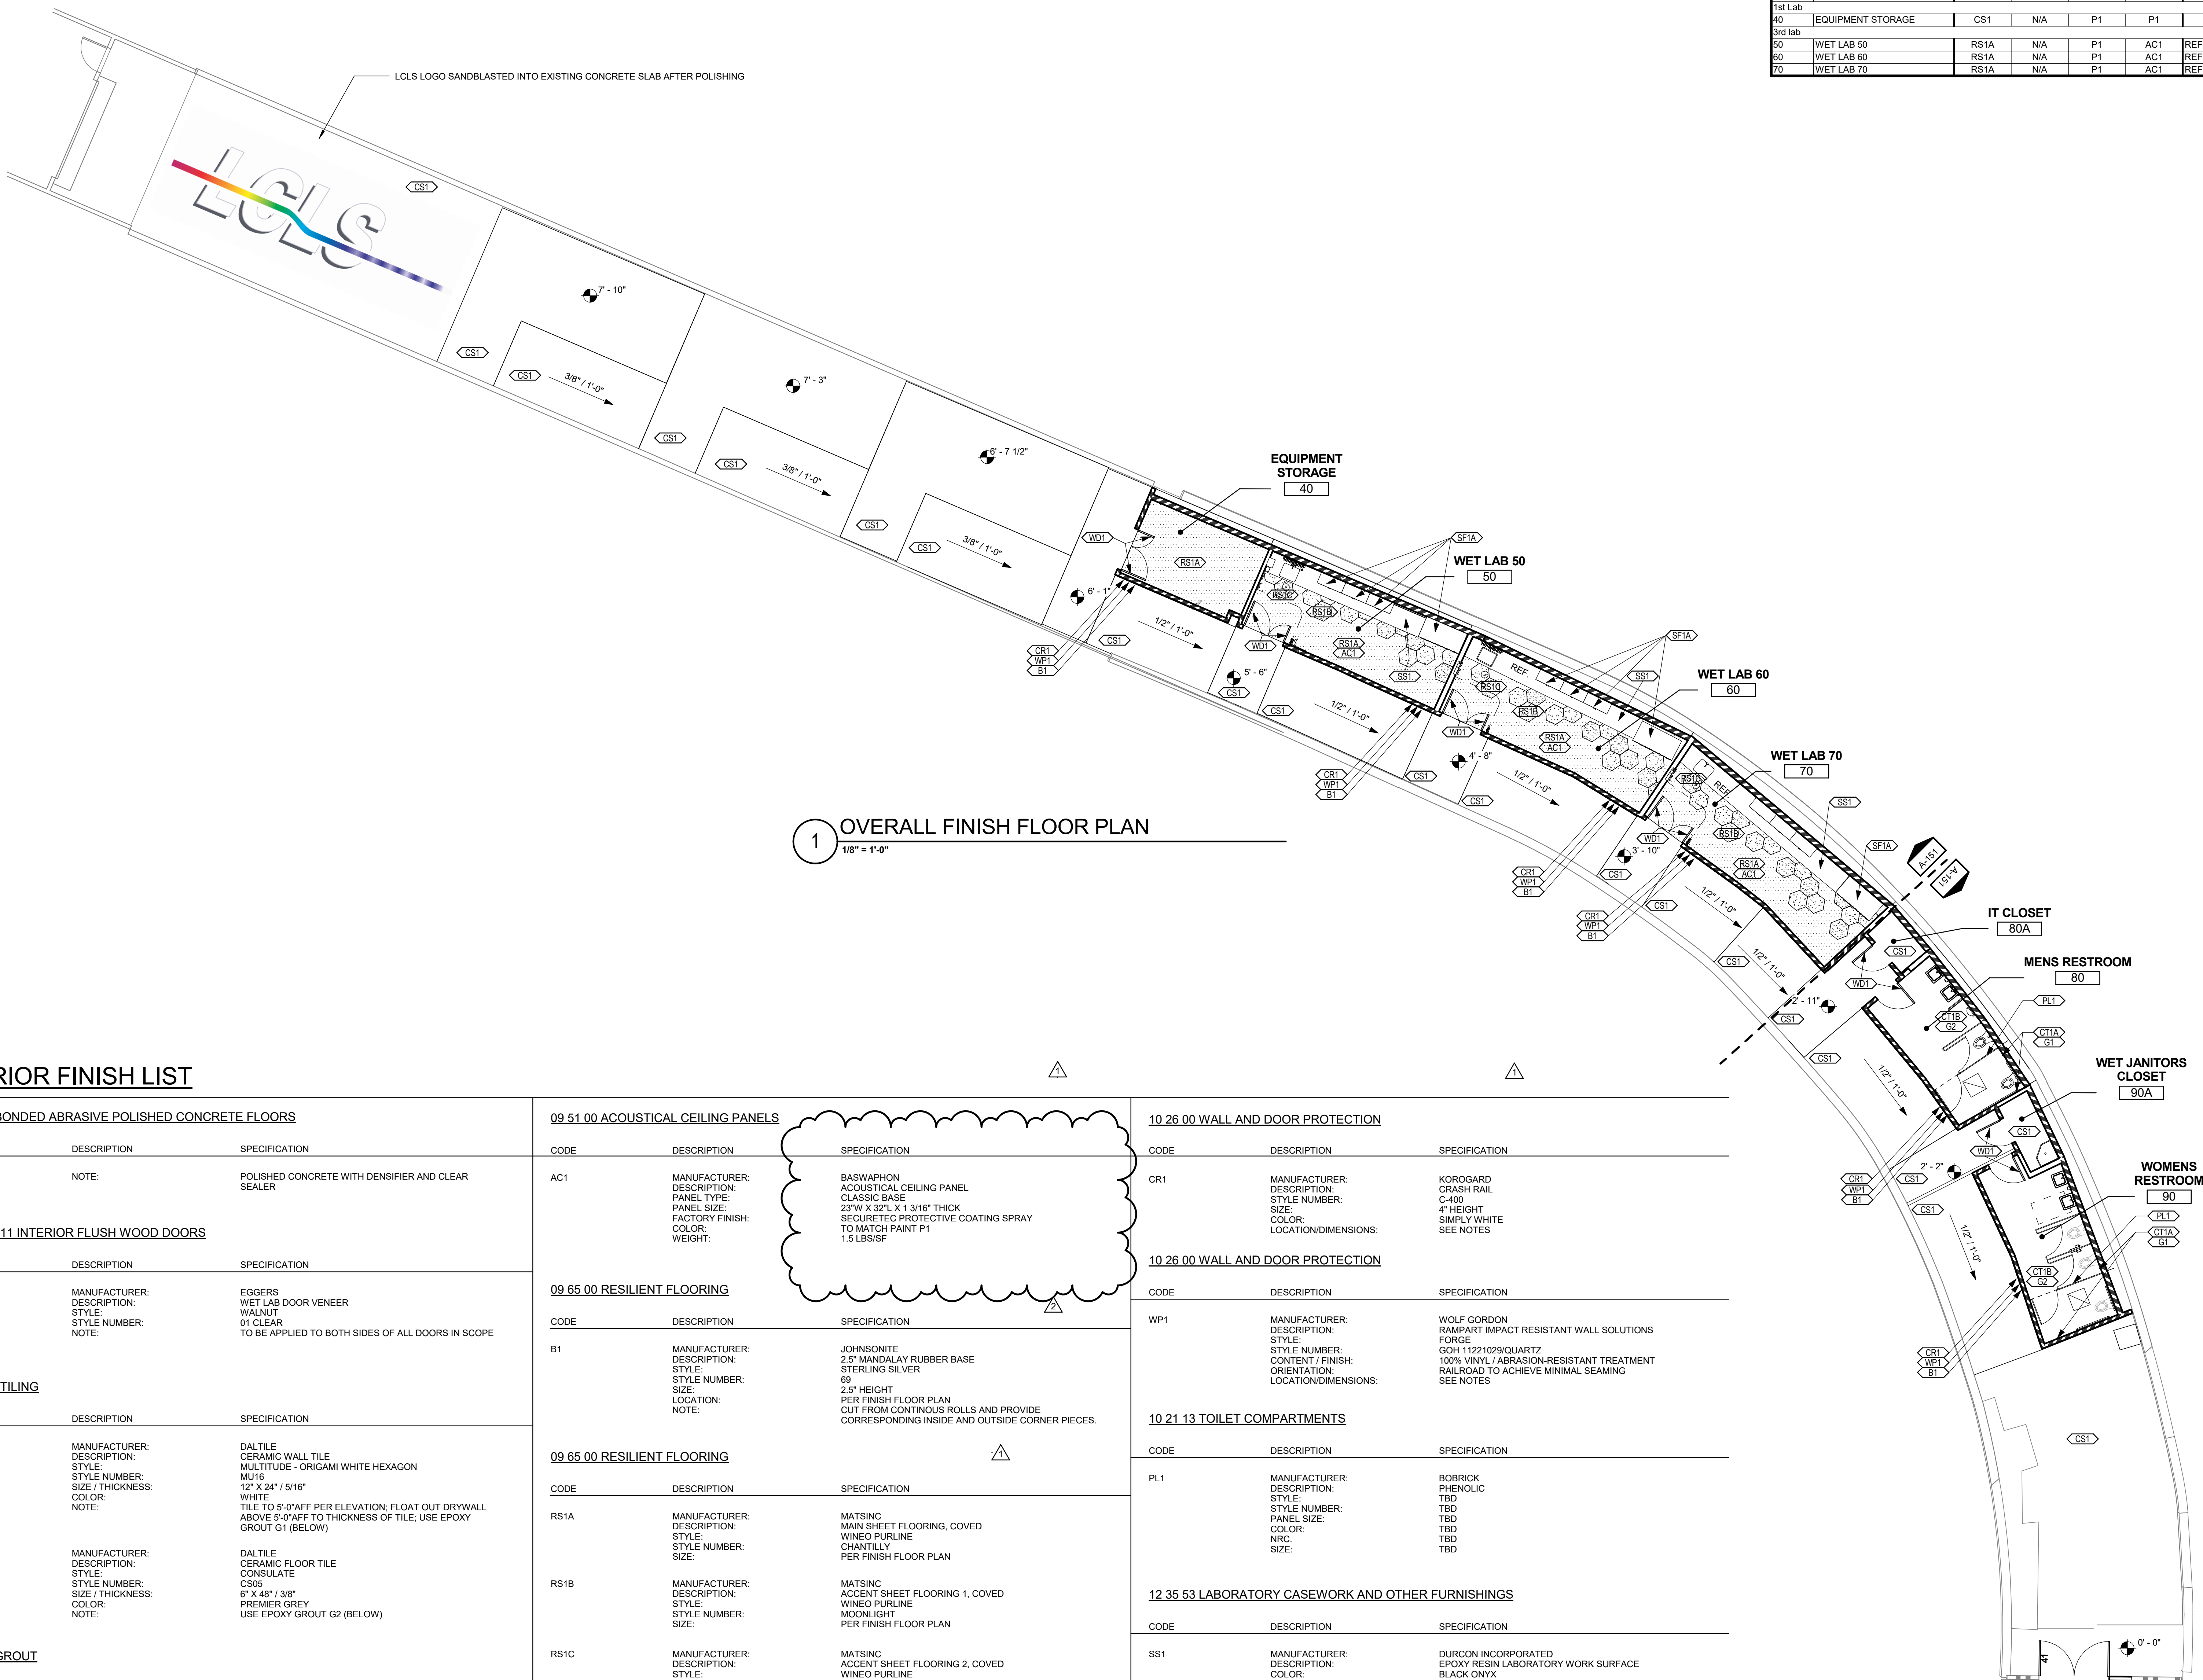
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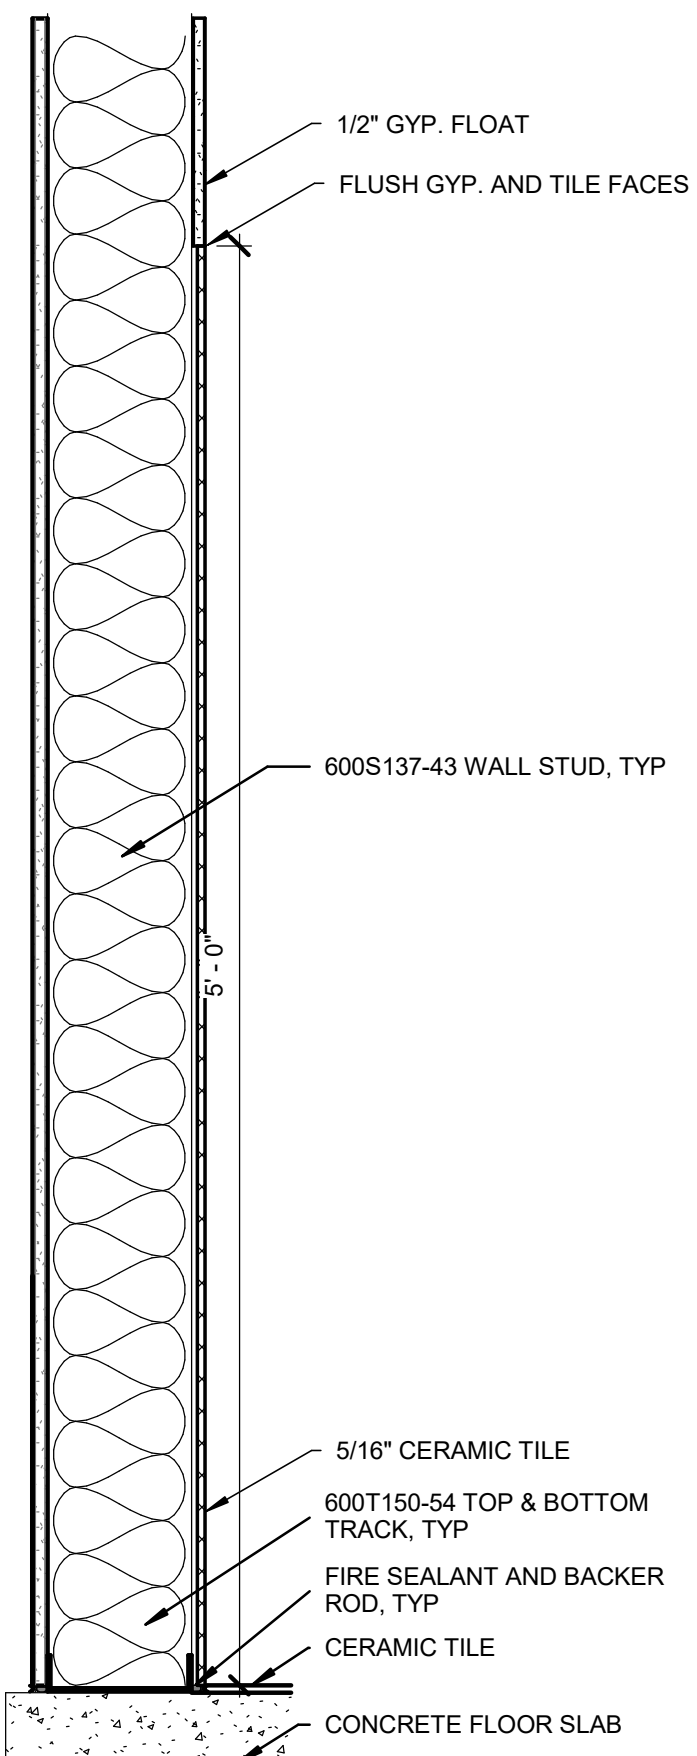
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ENR DES Designer CHKR Checker	DATE 02/01/2017 02/01/2017	APPROVALS DATE 01/06/2017	DRAWING NUMBER B999A001-0025	REVISION A0
B999 FEH TUNNEL FACILITIES ARCHITECTURAL EDGE OF SLAB PLAN				E

ROOM FINISH SCHEDULE					
ROOM NO.	NAME	FLOOR	FINISH BASE	WALL	CEILING
LEVEL 2 - LOWER RESTROOM					
80	MENS RESTROOM	CT1B	N/A	CT1A	P1
80A	IT CLOSET	CS1	N/A	P1	P1
90	WOMENS RESTROOM	CT1B	N/A	CT1A	P1
90A	WET JANITORS CLOSET	CS1	N/A	P1	P1
40	EQUIPMENT STORAGE	CS1	N/A	P1	P1
50	WET LAB 50	RS1A	N/A	P1	AC1
60	WET LAB 60	RS1A	N/A	P1	AC1
70	WET LAB 70	RS1A	N/A	P1	AC1


Revision Schedule		
Revision Number	Revision Description	Revision Date
1	ADDENDUM 1	01/27/2017
2	ADDENDUM 2	02/01/2017

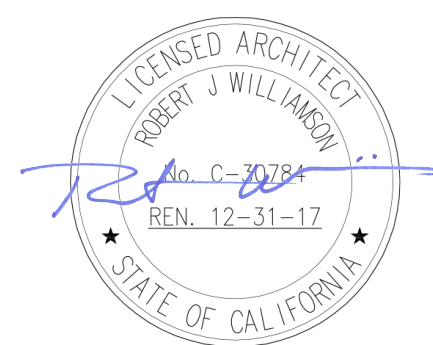

1 OVERALL FINISH FLOOR PLAN
1/8" = 1'-0"



2 TYP. WALL FLOAT AT TILED WALLS
1 1/2" = 1'-0"

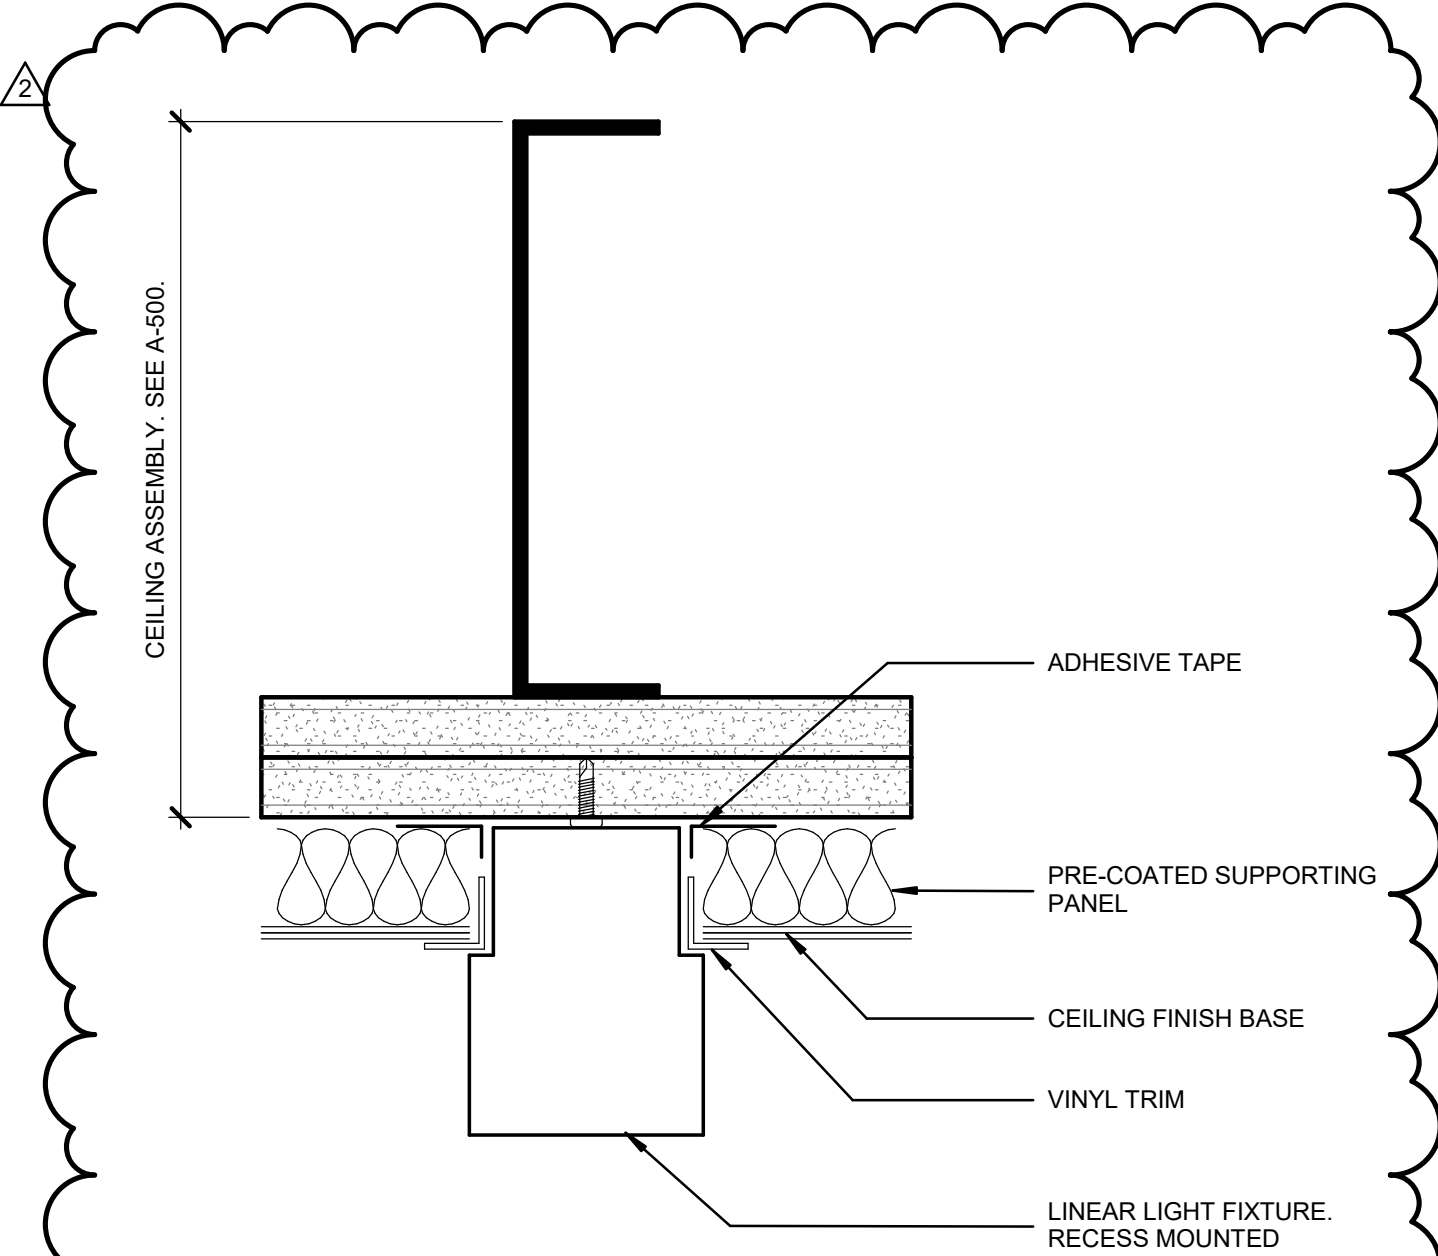

3 LIGHTING- ACP INTEGRATION DETAIL
8" = 1'-0"

SHEET NOTE ON 10 26 00 WALL AND DOOR PROTECTION:
CR1 NOTE:
 LOCATION PER FINISH FLOOR PLAN; CRASH RAILS SHALL BE CONTINUOUS ALONG LENGTH OF INTERIOR WALL SURFACE AT APPROXIMATELY 36" AFF. INSTALLED PARALLEL TO ADJACENT FLOOR SLOPE. OFFSET EACH CRASH RAIL WIDTH 2" INWARD FROM EACH MEASURED LENGTH. DISCONTINUE AT DOOR FRAMES.
WP1 NOTE:
 LOCATION PER FINISH FLOOR PLAN; TOP OF WALL PROTECTION TO OCCUR AT BASE OF EACH CRASH RAIL LENGTH.

INTERIOR FINISH LIST

03 35 43 BONDED ABRASIVE POLISHED CONCRETE FLOORS		
CODE	DESCRIPTION	SPECIFICATION
CS1	NOTE:	POLISHED CONCRETE WITH DENSIFIER AND CLEAR SEALER
08 14 16.11 INTERIOR FLUSH WOOD DOORS		
CODE	DESCRIPTION	SPECIFICATION
WD1	MANUFACTURER: DESCRIPTION: STYLE: STYLE NUMBER: NOTE:	EGGERS WET LAB DOOR VENEER WALNUT 01 CLEAR TO BE APPLIED TO BOTH SIDES OF ALL DOORS IN SCOPE
09 30 00 TILING		
CODE	DESCRIPTION	SPECIFICATION
CT1A	MANUFACTURER: DESCRIPTION: STYLE: STYLE NUMBER: SIZE / THICKNESS: NOTE:	DALTILE CERAMIC WALL TILE MULTITUDE - ORIGAMI WHITE HEXAGON MU16 12" X 24" / 5/16" WHITE TILE TO 5'-0" AFF PER ELEVATION; FLOAT OUT DRYWALL ABOVE 5'-0" AFF TO THICKNESS OF TILE; USE EPOXY GROUT G1 (BELOW)
CT1B	MANUFACTURER: DESCRIPTION: STYLE: STYLE NUMBER: SIZE / THICKNESS: NOTE:	DALTILE CERAMIC FLOOR TILE CONSULATE CS06 6" X 48" / 3/8" PREMIER GREY USE EPOXY GROUT G2 (BELOW)
09 30 00 GROUT		
CODE	DESCRIPTION	SPECIFICATION
G1	MANUFACTURER: DESCRIPTION: STYLE: STYLE NUMBER: COLOR: NOTE:	ARDEX TILE & STONE INSTALLATION SYSTEMS ARDEX WA - EPOXY GROUT & ADHESIVE 35 BRILLIANT WHITE USE WITH CT1A (ABOVE)
G2	MANUFACTURER: DESCRIPTION: STYLE: STYLE NUMBER: COLOR: NOTE:	ARDEX TILE & STONE INSTALLATION SYSTEMS ARDEX WA - EPOXY GROUT & ADHESIVE 10 IRISH CREME USE WITH CT1B (ABOVE)

09 51 00 ACOUSTICAL CEILING PANELS		
CODE	DESCRIPTION	SPECIFICATION
AC1	MANUFACTURER: DESCRIPTION: PANEL TYPE: PANEL SIZE: FACTORY FINISH: COLOR: WEIGHT:	BASWAPHON ACOUSTICAL CEILING PANEL CLASSIC BASE 23"W X 32"L X 1 3/16" THICK SECURETEC PROTECTIVE COATING SPRAY TO MATCH PAINT P1 1.5 LB/SF
09 65 00 RESILIENT FLOORING		
CODE	DESCRIPTION	SPECIFICATION
B1	MANUFACTURER: DESCRIPTION: STYLE: STYLE NUMBER: SIZE: LOCATION: NOTE:	JOHNSONITE 2.5" MANDALAY RUBBER BASE STERLING SILVER 69 2.5" HEIGHT PER FINISH FLOOR PLAN CUT FROM CONTINUOUS ROLLS AND PROVIDE CORRESPONDING INSIDE AND OUTSIDE CORNER PIECES.
09 65 00 RESILIENT FLOORING		
CODE	DESCRIPTION	SPECIFICATION
RS1A	MANUFACTURER: DESCRIPTION: STYLE: STYLE NUMBER: SIZE:	MATSING MAIN SHEET FLOORING, COVED WINEO PURLINE CHANTILLY PER FINISH FLOOR PLAN
RS1B	MANUFACTURER: DESCRIPTION: STYLE: STYLE NUMBER: SIZE:	MATSING ACCENT SHEET FLOORING 1, COVED WINEO PURLINE MOONLIGHT PER FINISH FLOOR PLAN
RS1C	MANUFACTURER: DESCRIPTION: STYLE: STYLE NUMBER: SIZE:	MATSING ACCENT SHEET FLOORING 2, COVED WINEO PURLINE TITANIUM PER FINISH FLOOR PLAN
09 91 23 INTERIOR PAINTING		
CODE	DESCRIPTION	SPECIFICATION
P1	FIELD PAINT MANUFACTURER: STYLE: COLOR: COLOR NUMBER: FINISH: NOTES:	BENJAMIN MOORE OFF WHITE SWISS COFFEE OC-45 EGGSHELL DOOR FRAMES TO MATCH ADJACENT PAINT COLOR IN SEMI-GLOSS FINISH.

10 26 00 WALL AND DOOR PROTECTION		
CODE	DESCRIPTION	SPECIFICATION
CR1	MANUFACTURER: DESCRIPTION: STYLE: STYLE NUMBER: SIZE: COLOR: LOCATION/DIMENSIONS:	KOROGARD CRASH RAIL CLASSIC C-400 4" HEIGHT SIMPLY WHITE SEE NOTES
10 26 00 WALL AND DOOR PROTECTION		
CODE	DESCRIPTION	SPECIFICATION
WP1	MANUFACTURER: DESCRIPTION: STYLE: STYLE NUMBER: CONTENT / FINISH: ORIENTATION: LOCATION/DIMENSIONS:	WOLF GORDON RAINPAINT IMPACT RESISTANT WALL SOLUTIONS FORGE GOH 11221029QUARTZ 100% VINYL / ABRASION-RESISTANT TREATMENT RAILROAD TO ACHIEVE MINIMAL SEAMING SEE NOTES
10 21 13 TOILET COMPARTMENTS		
CODE	DESCRIPTION	SPECIFICATION
PL1	MANUFACTURER: DESCRIPTION: STYLE: STYLE NUMBER: PANEL SIZE: COLOR: NRC: SIZE:	BOBRICK PHENOLIC TBD TBD TBD TBD TBD
12 35 53 LABORATORY CASEWORK AND OTHER FURNISHINGS		
CODE	DESCRIPTION	SPECIFICATION
SS1	MANUFACTURER: DESCRIPTION: COLOR:	DURCON INCORPORATED EPOXY RESIN LABORATORY WORK SURFACE BLACK ONYX
12 35 53 LABORATORY CASEWORK AND OTHER FURNISHINGS		
CODE	DESCRIPTION	SPECIFICATION
SF1A	MANUFACTURER: DESCRIPTION: COLOR: COLOR NUMBER:	KEVAUNEE RESEARCH COLLECTION - STEEL FINISH FOR UPPERS LIGHT NEUTRAL NO. 61
SF1B	MANUFACTURER: DESCRIPTION: COLOR: COLOR NUMBER:	KEVAUNEE RESEARCH COLLECTION - STEEL FINISH FOR UPPERS WINEBERRY NO. 96

FINISH LEGEND
1/4" = 1'-0"

Revision Schedule		
Revision Number	Revision Description	Revision Date
1	ADDENDUM 1	1/27/2017
2	ADDENDUM 2	2/1/2017

PANEL NAME: IPC01-999A		CONNECTED: 19.71 kVA		
TYPE:	GROUND BUS	MAIN:		
MOUNTING:		VOLTS: 208/120		
FED FROM:		PHASE: 3		
LOCATION:		WIRE: 4		
XFMR:		SCCR:		
Notes:				
CKT	LOAD DESCRIPTION	Load	BREAKER POLES	BREAKER AMPS
1	WIREWAY WET LAB 3	0.72 kVA	1	20 A
2	WIREWAY WET LAB 3	0.72 kVA	1	20 A
3	WIREWAY WET LAB 3	0.72 kVA	1	20 A
4	RECEPT WET LAB 3	0.54 kVA	1	20 A
5	DEDCT RECEPT WET LAB 3	0.18 kVA	1	20 A
6	DEDCT RECEPT WET LAB 3	0.18 kVA	1	20 A
7	FUMHOOD WET LAB#3	1.5 kVA	1	20 A
8	WIREWAY WET LAB 2	0.72 kVA	1	20 A
9	WIREWAY WET LAB 2	0.72 kVA	1	20 A
10	WIREWAY WET LAB 2	0.72 kVA	1	20 A
11	RECEPT WET LAB 2	0.54 kVA	1	20 A
12	DEDCT RECEPT WET LAB 2	0.18 kVA	1	20 A
13	DEDCT RECEPT WET LAB 2	0.18 kVA	1	20 A
14	FUMHOOD WET LAB#2	1.5 kVA	1	20 A
15	WIREWAY WET LAB 1	0.72 kVA	1	20 A
16	WIREWAY WET LAB 1	0.72 kVA	1	20 A
17	WIREWAY WET LAB 1	0.72 kVA	1	20 A
18	RECEPT WET LAB 1	0.54 kVA	1	20 A
19	DEDCT RECEPT WET LAB 1	0.18 kVA	1	20 A
20	DEDCT RECEPT WET LAB 1	0.18 kVA	1	20 A
21	FUMHOOD WET LAB#1	1.5 kVA	1	20 A
22	RECEPT ACCESS RESTRM	0.9 kVA	1	20 A
23	LIGHTING WET LAB 3	0.15 kVA	1	20 A
24	LIGHTING WET LAB 2	0.15 kVA	1	20 A
25	LIGHTING WET LAB 1	0.15 kVA	1	20 A
26	LIGHTING RESTROOMS	0.15 kVA	1	20 A
27	RECEPT CORRIDOR	1.26 kVA	1	20 A
28	DAS AMPLIFIER	0.36 kVA	1	20 A
29	IT SERVER	0.36 kVA	1	20 A
30	CARD ACCESS	0.18 kVA	1	20 A
31	LIGHTING EQUIPMENT STORAGE ROOM	0 kVA	1	20 A
32	FIRE SMOKE DAMPER	0.6 kVA	1	20 A
33	WIREWAY 1 - EQUIP ROOM	0.72 kVA	1	20 A
34	PUMP - CP-1	0.15 kVA	1	20 A
35	WIREWAY 2 - EQUIP ROOM	0.72 kVA	1	20 A
36	WATER HEATER CONTROLS	0.18 kVA	1	20 A
37				
38				
39				
40				
41				
42		19.71 kVA		
		54.7 A		
Notes: ALL BRANCH CIRCUIT WIRING SHALL BE LOW LEAKAGE CROSS LINKED POLYETHYLENE, WITH A DIELECTRIC... 3.5 OR LESS. COLOR CODED CONDUCTORS: ORANGE #1, BROWN #2, GREEN GROUND.				

</

E - VARIABLE FREQUENCY DRIVE SCHEDULE										
STARTER TYPE:				REMARKS:						
PWM - PULSE WIDTH MODULATED				SA - STANDARD ACCESSORIES						
12PWM - 12 PULSE PWM				(INCLUDES * ITEMS)						
18PWM - 18 PULSE PWM				*MA - MANUAL SPEED ADJUSTMENT						
LINE DISCONNECT:				*ET - ELECTRONIC THERMAL OVERLOADS						
DS - DISCONNECT SWITCH				*CT - CONTROL TRANSFORMER, FUSED, 120V						
FDS - FUSED DISCONNECT SWITCH				*HA - HAND-OFF-AUTO DOOR SWITCH						
CIRCUIT BREAKER				TO - MELTING THERMAL OVERLOADS						
CONTROL:				MOL - MULTIPLE MOTOR OVERLOADS						
PN - 3-15 PSI TRANSDUCER				HAR - PASSIVE HARMONIC FILTER						
420 - 4-20mA FOLLOWER										

LUMINAIRE SCHEDULE												
(MTG) MOUNTING:		(TYPE) LAMP TECHNOLOGY:				(L/L) LENS / LOUVER:						
RE - RECESSED		FL - FLUORESCENT				A - .125 ACRYLIC						
SP - SUSPENDED		CF - COMPACT FLUORESCENT				B - BLACK BAFFLE						
CL - CEILING SURFACE		HL - HALOGEN				C - CLEAR ALZAK						
WL - WALL		IN - INCANDESCENT				D - PARABOLIC						
UC - UNDER CABINET		LED - LIGHT EMITTING DIODE				F - FRESNEL						
CV - COVE		HS - HIGH PRESSURE SODIUM				G - TEMPERED GLASS						
PL - POLE		MH - METAL HALIDE				H - WALL WASHER						
FR - FLANGED RECESSED		SMH - SUPER METAL HALIDE				P - POLYCARBONATE						
O - OTHER (SEE DESCRIPTION)		PSMH - PULSE START METAL HALIDE				K - KSH12, 125" ACRYLIC						
		CMH - CERAMIC METAL HALIDE				K19 - KSH19, 156" ACRYLIC						
DOOR:		O - OTHER (SEE DESCRIPTION)				L - LOW IRIDESCENT SPECULAR ALUM.						
FA - FLAT ALUMINUM		XL - EXTENDED LIFE				N - NONE						
FS - FLAT STEEL		XLP - EXTENDED LIFE & OUTPUT				R - HIGH IMPACT OR ACRYLIC						
RA - REGRESSED ALUMINUM						O - OTHER (SEE DESCRIPTION)						
RS - REGRESSED STEEL												
		(TYPE) BALLAST:				(TYPE) BALLAST:						
FINISH:		DIM07 - LINE DIMMING BALLAST				EB - ELECTRONIC BALLAST						
PAF - PAINT AFTER FABRICATION		DIM10 - 0-10V DIMMING BALLAST				EM - EMERGENCY BATTERY / BALLAST						
CSA - FINISH SELECTION BY ARCHITECT		HL - HIGH / LOW LEVEL BALLAST				DALI - DIGITAL DIMMING BALLAST						
		ML - MULTILEVEL SWITCHING				MV - MULTI-VOLTAGE ELECTRONIC 120V-277V						
		HP - HIGH PERFORMANCE / LBF				PRS - ELECTRONIC PROGRAM RAPID START BALLAST						
CATALOG NUMBER SHALL NOT BE CONSIDERED COMPLETE AND MATERIAL SHALL NOT BE ORDERED BY MANUFACTURER AND CATALOG NUMBER ONLY. THE COMPLETE DESCRIPTION AND THE SPECIFICATION SHALL BE COORDINATED WITH THE CATALOG NUMBER TO DETERMINE THE EXACT MATERIAL AND ACCESSORIES TO BE ORDERED. THE FIRST MANUFACTURER LISTED IS THE BASIS FOR DESIGN.												
REFER TO SPECIFICATION SECTIONS LIGHTING [16510 28 51 00 AND EMERGENCY LIGHTING 16535 28 52 00] FOR ADDITIONAL INFORMATION AND REQUIREMENTS.												
ALL LAMPS FOR THIS PROJECT SHALL BE FURNISHED AND INSTALLED BY THE ELECTRICAL CONTRACTOR UNLESS OTHERWISE NOTED.												
FLUORESCENT LAMP CORRELATED COLOR TEMPERATURE 4100°K, 3500°, 3000°K, COLOR RENDERING INDEX (CRI) AT OR ABOVE 95 FOR INTERIOR APPLICATIONS.												
LED LAMP COLOR RENDERING INDEX (CRI) AT OR ABOVE 85 FOR INTERIOR APPLICATIONS.												
ITEM	DESCRIPTION	DIMENSIONS			MTG	TYPE	LAMPS	MODEL	BALLAST	TYPE	L/L	APPROVED MANUFACTURER
		L	W	H			QTY		VOLTS			
F1	LED CONTEMPORARY CYLINDER VANITY, 2 FT	4"	4"		WL	LED	1	MIN 1350 L MAX 10 W	120 V	120V	O	LITHONIA FMVCCCL24MMVOLT35K 90CRBN OR APPROVED EQUAL
F2	LED 6" ENERGY STAR DOWNLIGHT			9 1/2"	6"	RE	LED	1	MIN 1000 L MAX 11 W	120 V	ED	O LITHONIA REAL60GBNESL1000L35 K 60SCL7XLED124 OR APPROVED EQUAL
F2E	SIMILAR TO F2 EMERGENCY BALLAST			9 1/2"	6"	RE	LED	1	MIN 1000 L MAX 11 W	120 V	EM	O LITHONIA REAL60GBNESL1000L35 K 60SCL7XLED124 OR APPROVED EQUAL
F3	LED 4" LINEAR SURFACE SCALED WRAP	4"	4"			CL	LED	1	MIN 3600 L MAX 36 W	120 V	ED	O LITHONIA S1LED36S04SAL TMWU NUSUR OR APPROVED EQUAL
F3A	LED 4" DIRECT DISTRIBUTION	4"	4"			CL	LED	1	MIN 1696 L MAX 18.6 W	120 V	ED	O PINNACLE EX12HEN-35 4-UNV-10 OR APPROVED EQUAL
F4	LED 31" UNDERCABINET	2'-7 19/64"	2 51/64"	45/64"		UC	LED	1	MIN 1224 L MAX 18 W	120 V	ED	O UNILUM SLIMLINE 700UCF3195B-LED OR APPROVED EQUAL
F5	4FT INDUSTRIAL BACK OF HOUSE LUMINAIRE, LED, DIE FORMED 22-GAUGE STEEL HOUSING, DIFFUSED LENS	4"	4"			CL	LED	1	MIN 1500 L MAX 18 W	120 V	120V	O LITHONIA ZL1NL241500L MFSTMVTO LT3K60CRWH OR APPROVED EQUAL

REGISTERED PROFESSIONAL ENGINEER
DAVID E. MARSHALL
NO. E12921
Exp. 3-31-17
ELECTRICAL
STATE OF CALIFORNIA

B999E300-0062

SCALE:	DO NOT SCALE DRAWINGS	B999E300-0062.dwg	E300	1 of 1
B999 FEH TUNNEL FACILITIES ELECTRICAL SCHEDULES				
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B999E300-0062	A0	E		

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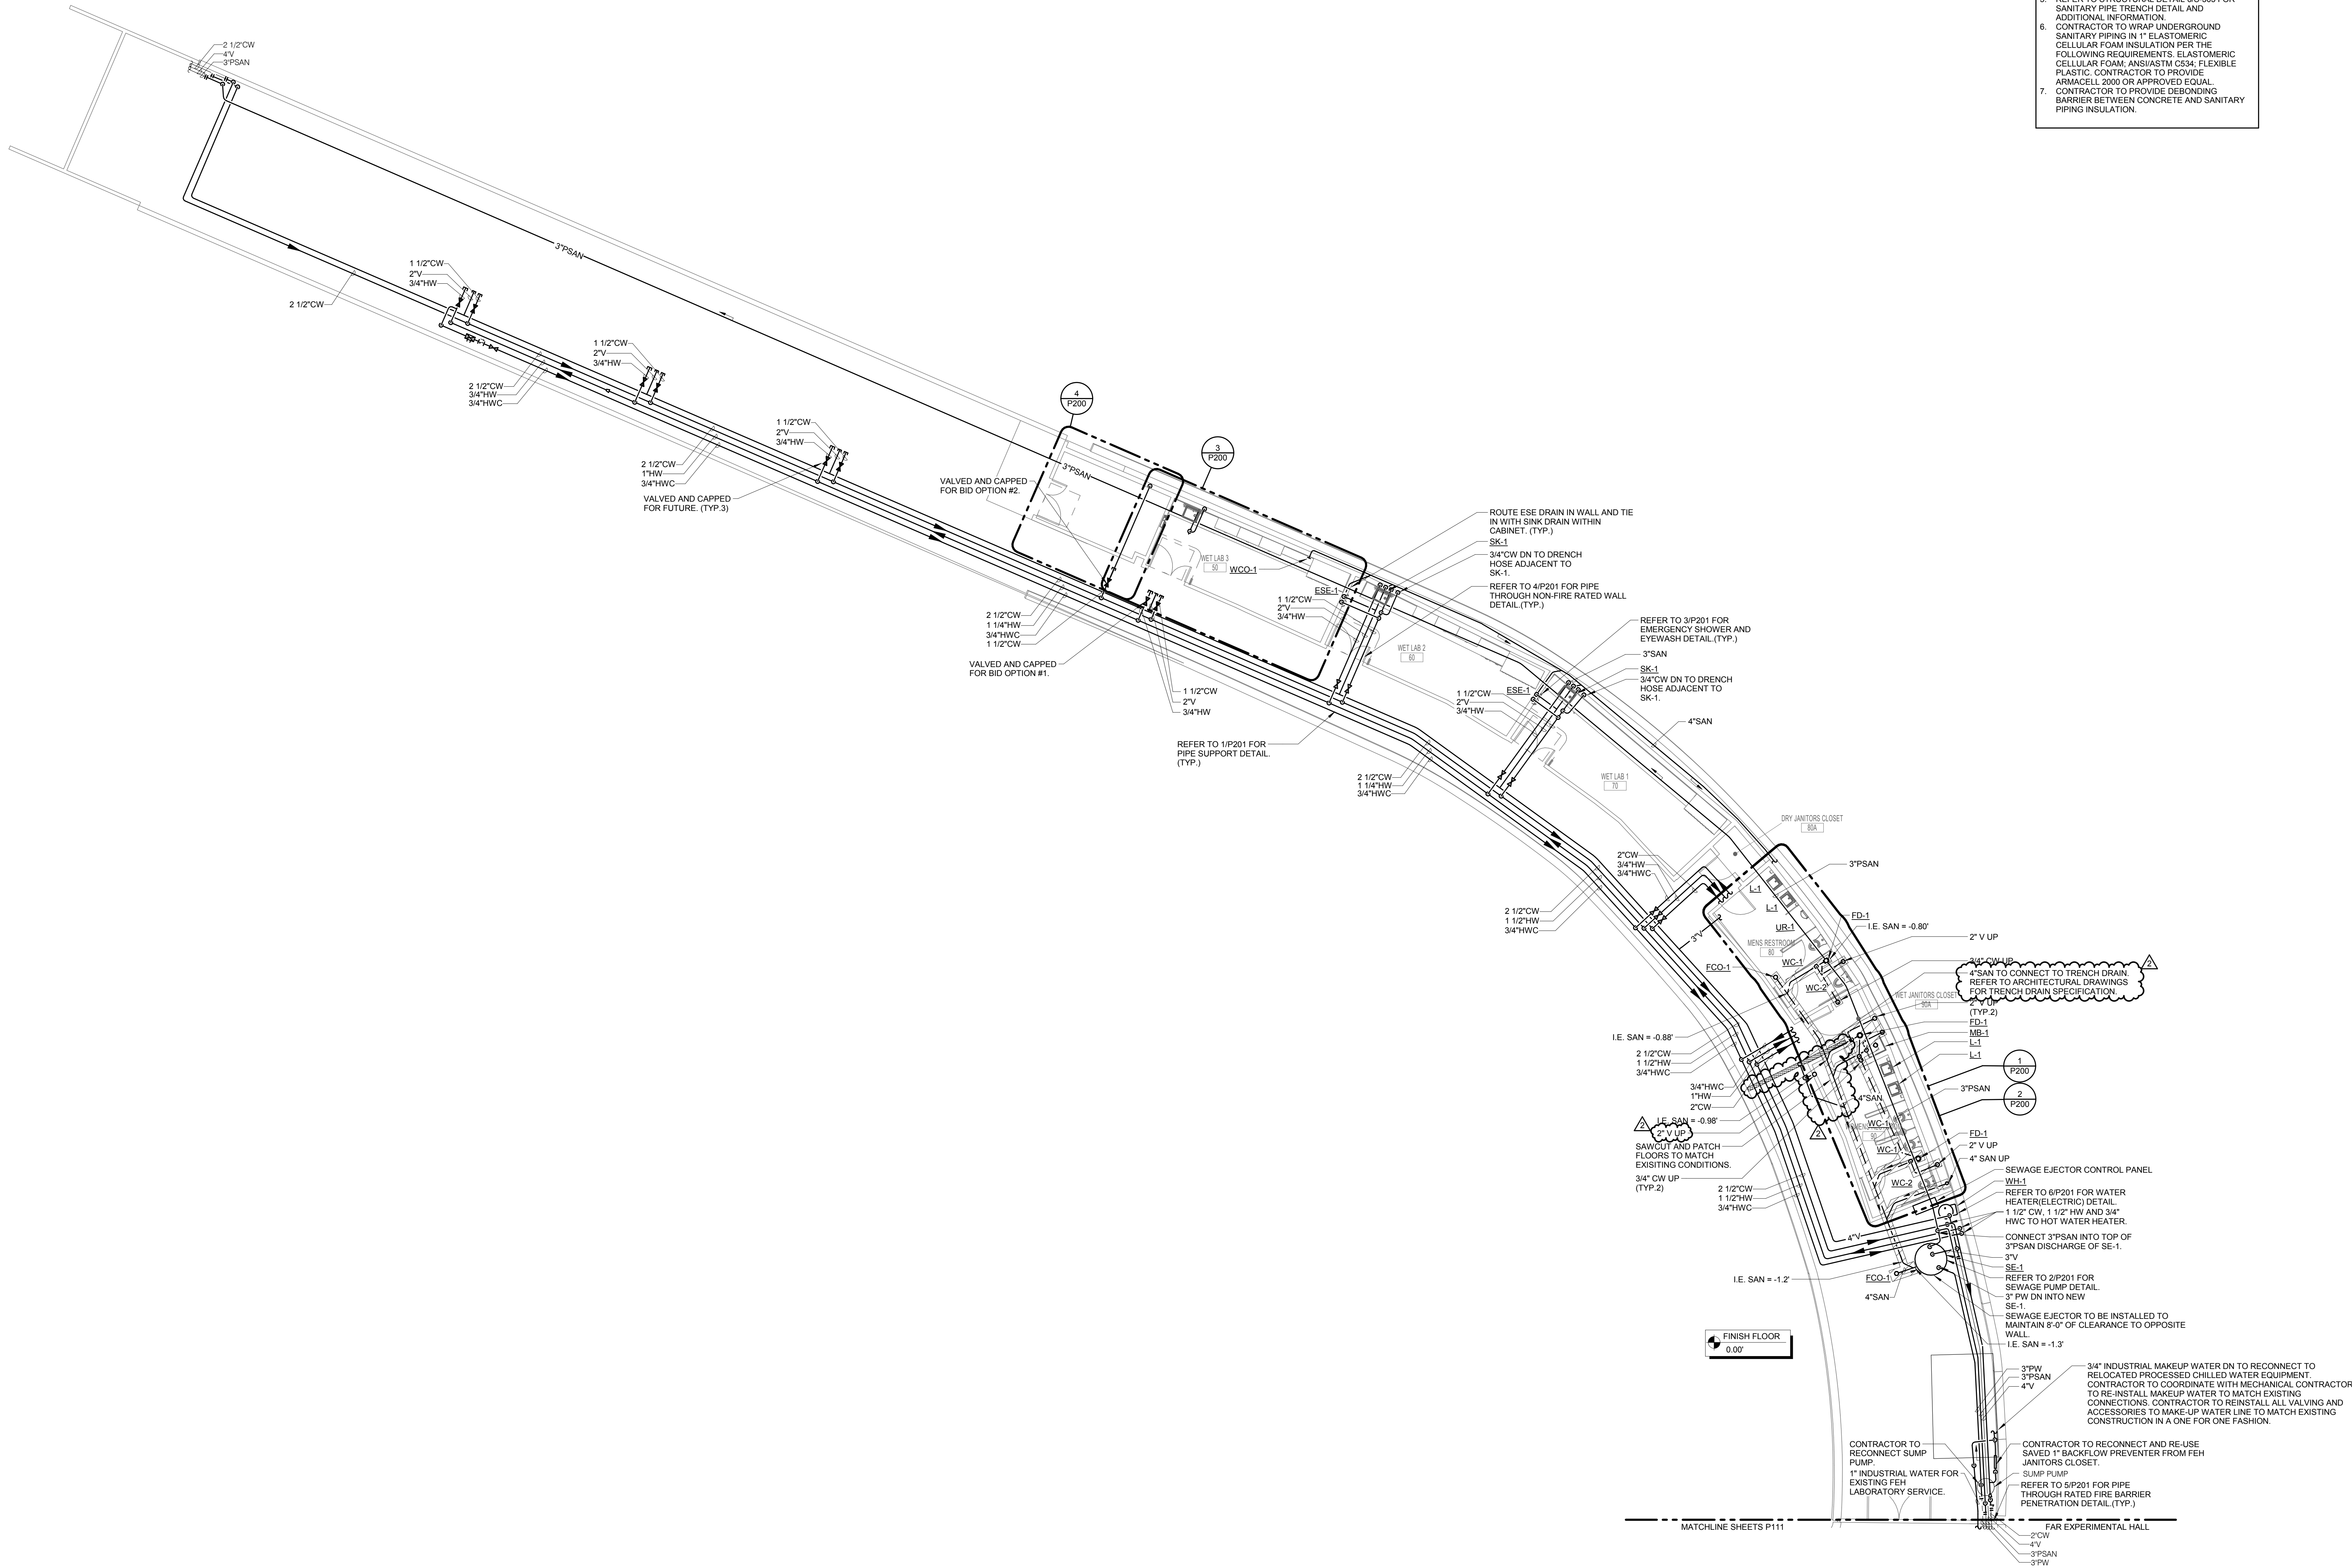
ENGR. B. LOPEZ
DES. B. LOPEZ
CHKR. J. LEESMAN

DATE
2/1/2017
2/1/2017
2/1/2017

APPROVALS
DATE
2/1/2017

- GENERAL SHEET NOTES:
1. CONTRACTOR IS RESPONSIBLE FOR PROVIDING ALL NEW VENT, COLD WATER, AND PUMPED SANITARY PIPING IN ORDER TO PROVIDE THE PIPING IN THEIR NEW LOCATION. CONTRACTOR IS ALLOWED TO RE-USE THE DEMOLISHED PIPING WHERE FEASIBLE FOR NEW ROUTING. CONTRACTOR IS RESPONSIBLE FOR REVIEWING THE EXISTING CONDITION OF THE PIPING PRIOR TO BIDDING TO CONFIRM AMOUNT OF PIPING PLANNED FOR RE-USE.
 2. CONTRACTOR SHALL LOCATE VENT, DOMESTIC COLD WATER, AND PUMPED SANITARY WASTE ABOVE NEW CEILING LEVEL REFER TO 1/P300 FOR FURTHER DETAIL.
 3. REFER TO PLUMBING ROUGH IN SCHEDULE ON SHEET P000 FOR SIZES OF BRANCH PIPING TO INDIVIDUAL FIXTURES.
 4. INVERT ELEVATIONS SHOWN BELOW ARE TO BE MEASURED FROM THE TOP OF THE EXISTING FLOOR SLAB.
 5. REFER TO STRUCTURAL DETAIL 6/S-303 FOR SANITARY PIPE TRENCH DETAIL AND ADDITIONAL INFORMATION.
 6. CONTRACTOR TO WRAP UNDERGROUND SANITARY PIPING IN 1" ELASTOMERIC CELLULAR FOAM INSULATION PER THE FOLLOWING REQUIREMENTS: ELASTOMERIC CELLULAR FOAM: ANSI/ASTM C534; FLEXIBLE PLASTIC: CONTRACTOR TO PROVIDE ARMACELL 2000 OR APPROVED EQUAL.
 7. CONTRACTOR TO PROVIDE DEBONDING BARRIER BETWEEN CONCRETE AND SANITARY PIPING INSULATION.

Revision Schedule		
Revision Number	Revision Description	Revision Date
1	ADDENDUM 1	1/27/2017
2	ADDENDUM 2	2/1/2017



ACCESS TUNNEL FLOOR PLAN - PLUMBING

1/8" = 1'-0"

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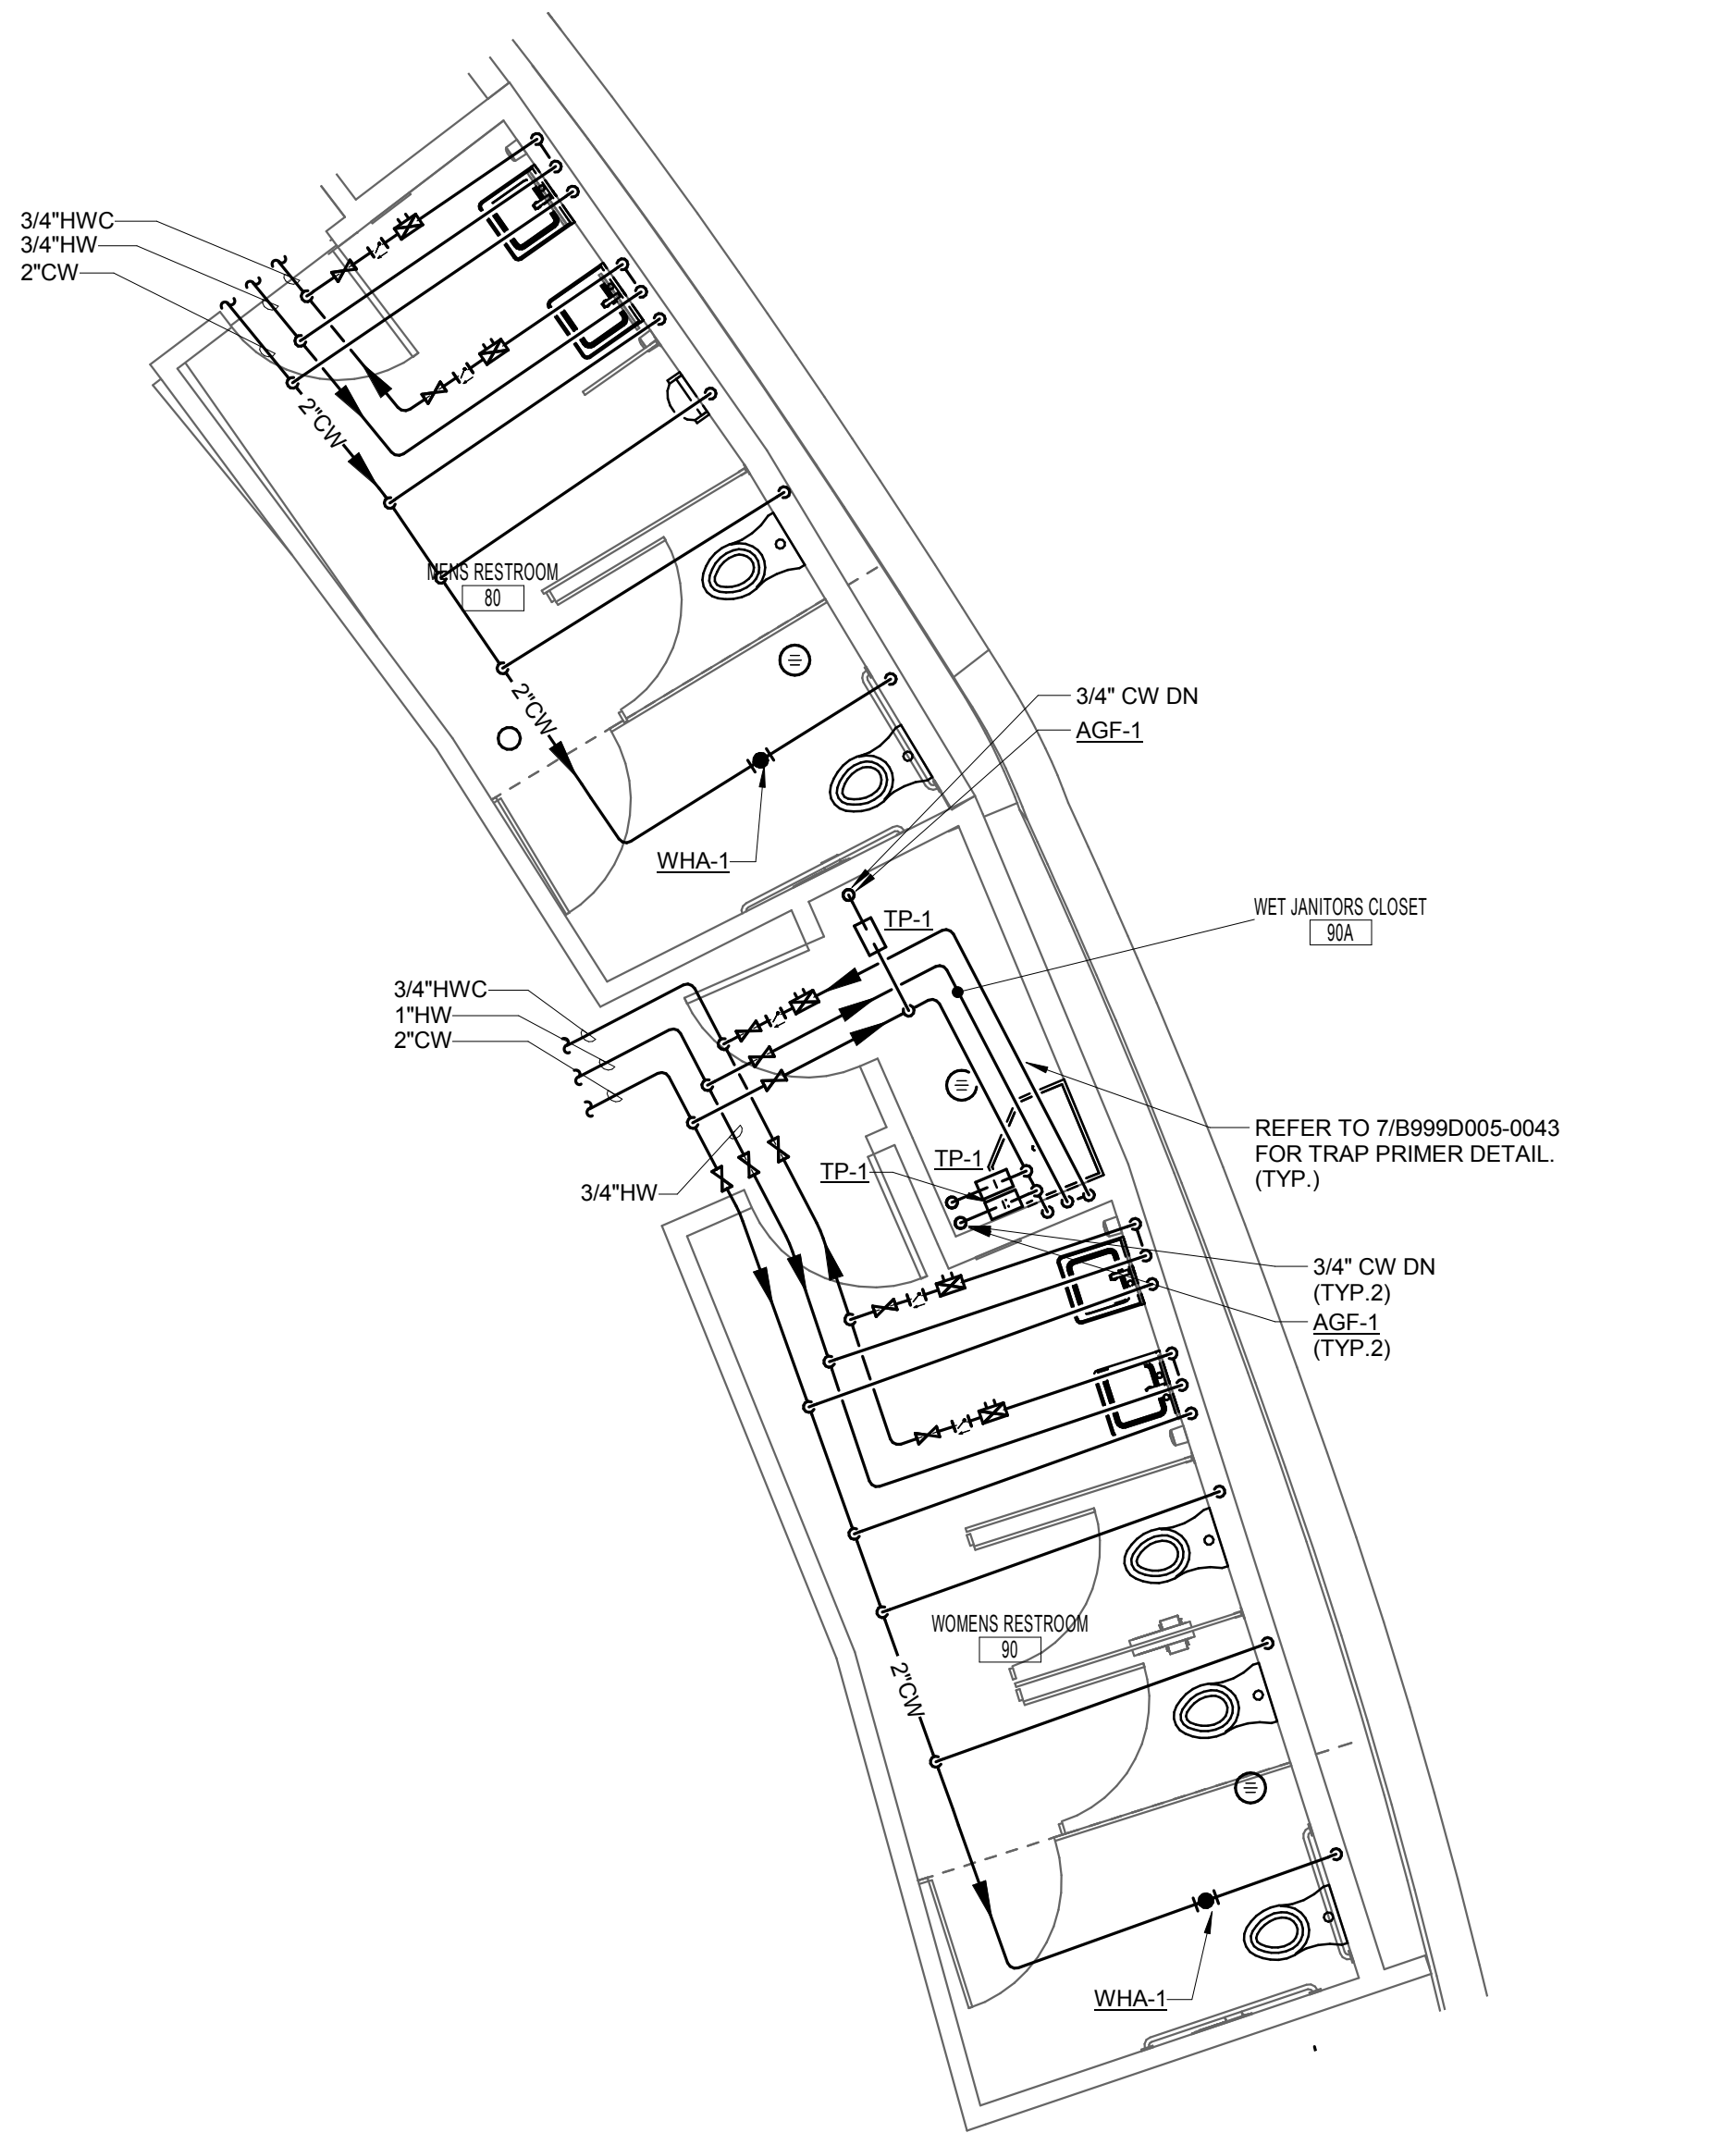
4670 WILLOW ROAD
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PLEASANTON, CA 94588
925-396-7700
925-396-7799 (FAX)

TAYLOR
Design
26 O'FARRELL STREET, 2ND FLOOR
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www.WeAreTaylor.com
415.992.4455


SCALE: 1/8" = 1'-0"	DO NOT SCALE DRAWINGS	B999D001-0041.dwg	P110	1 of 1
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ENGR T. DODAS DES T. DODAS CHKR D. HICKMAN	DATE 2/1/2017 2/1/2017 2/1/2017	APPROVALS 2/1/2017	DRAWING NUMBER B999D001-0041	REVISION A0
B999 FEH TUNNEL FACILITIES PLUMBING ACCESS TUNNEL FLOOR PLAN				E




Revision Schedule		
Revision Number	Revision Description	Revision Date
2	ADDENDUM 2	2/1/2017




1 ENLARGED PLAN - ACCESS TUNNEL FLOOR - DOMESTIC
1/4" = 1'-0"

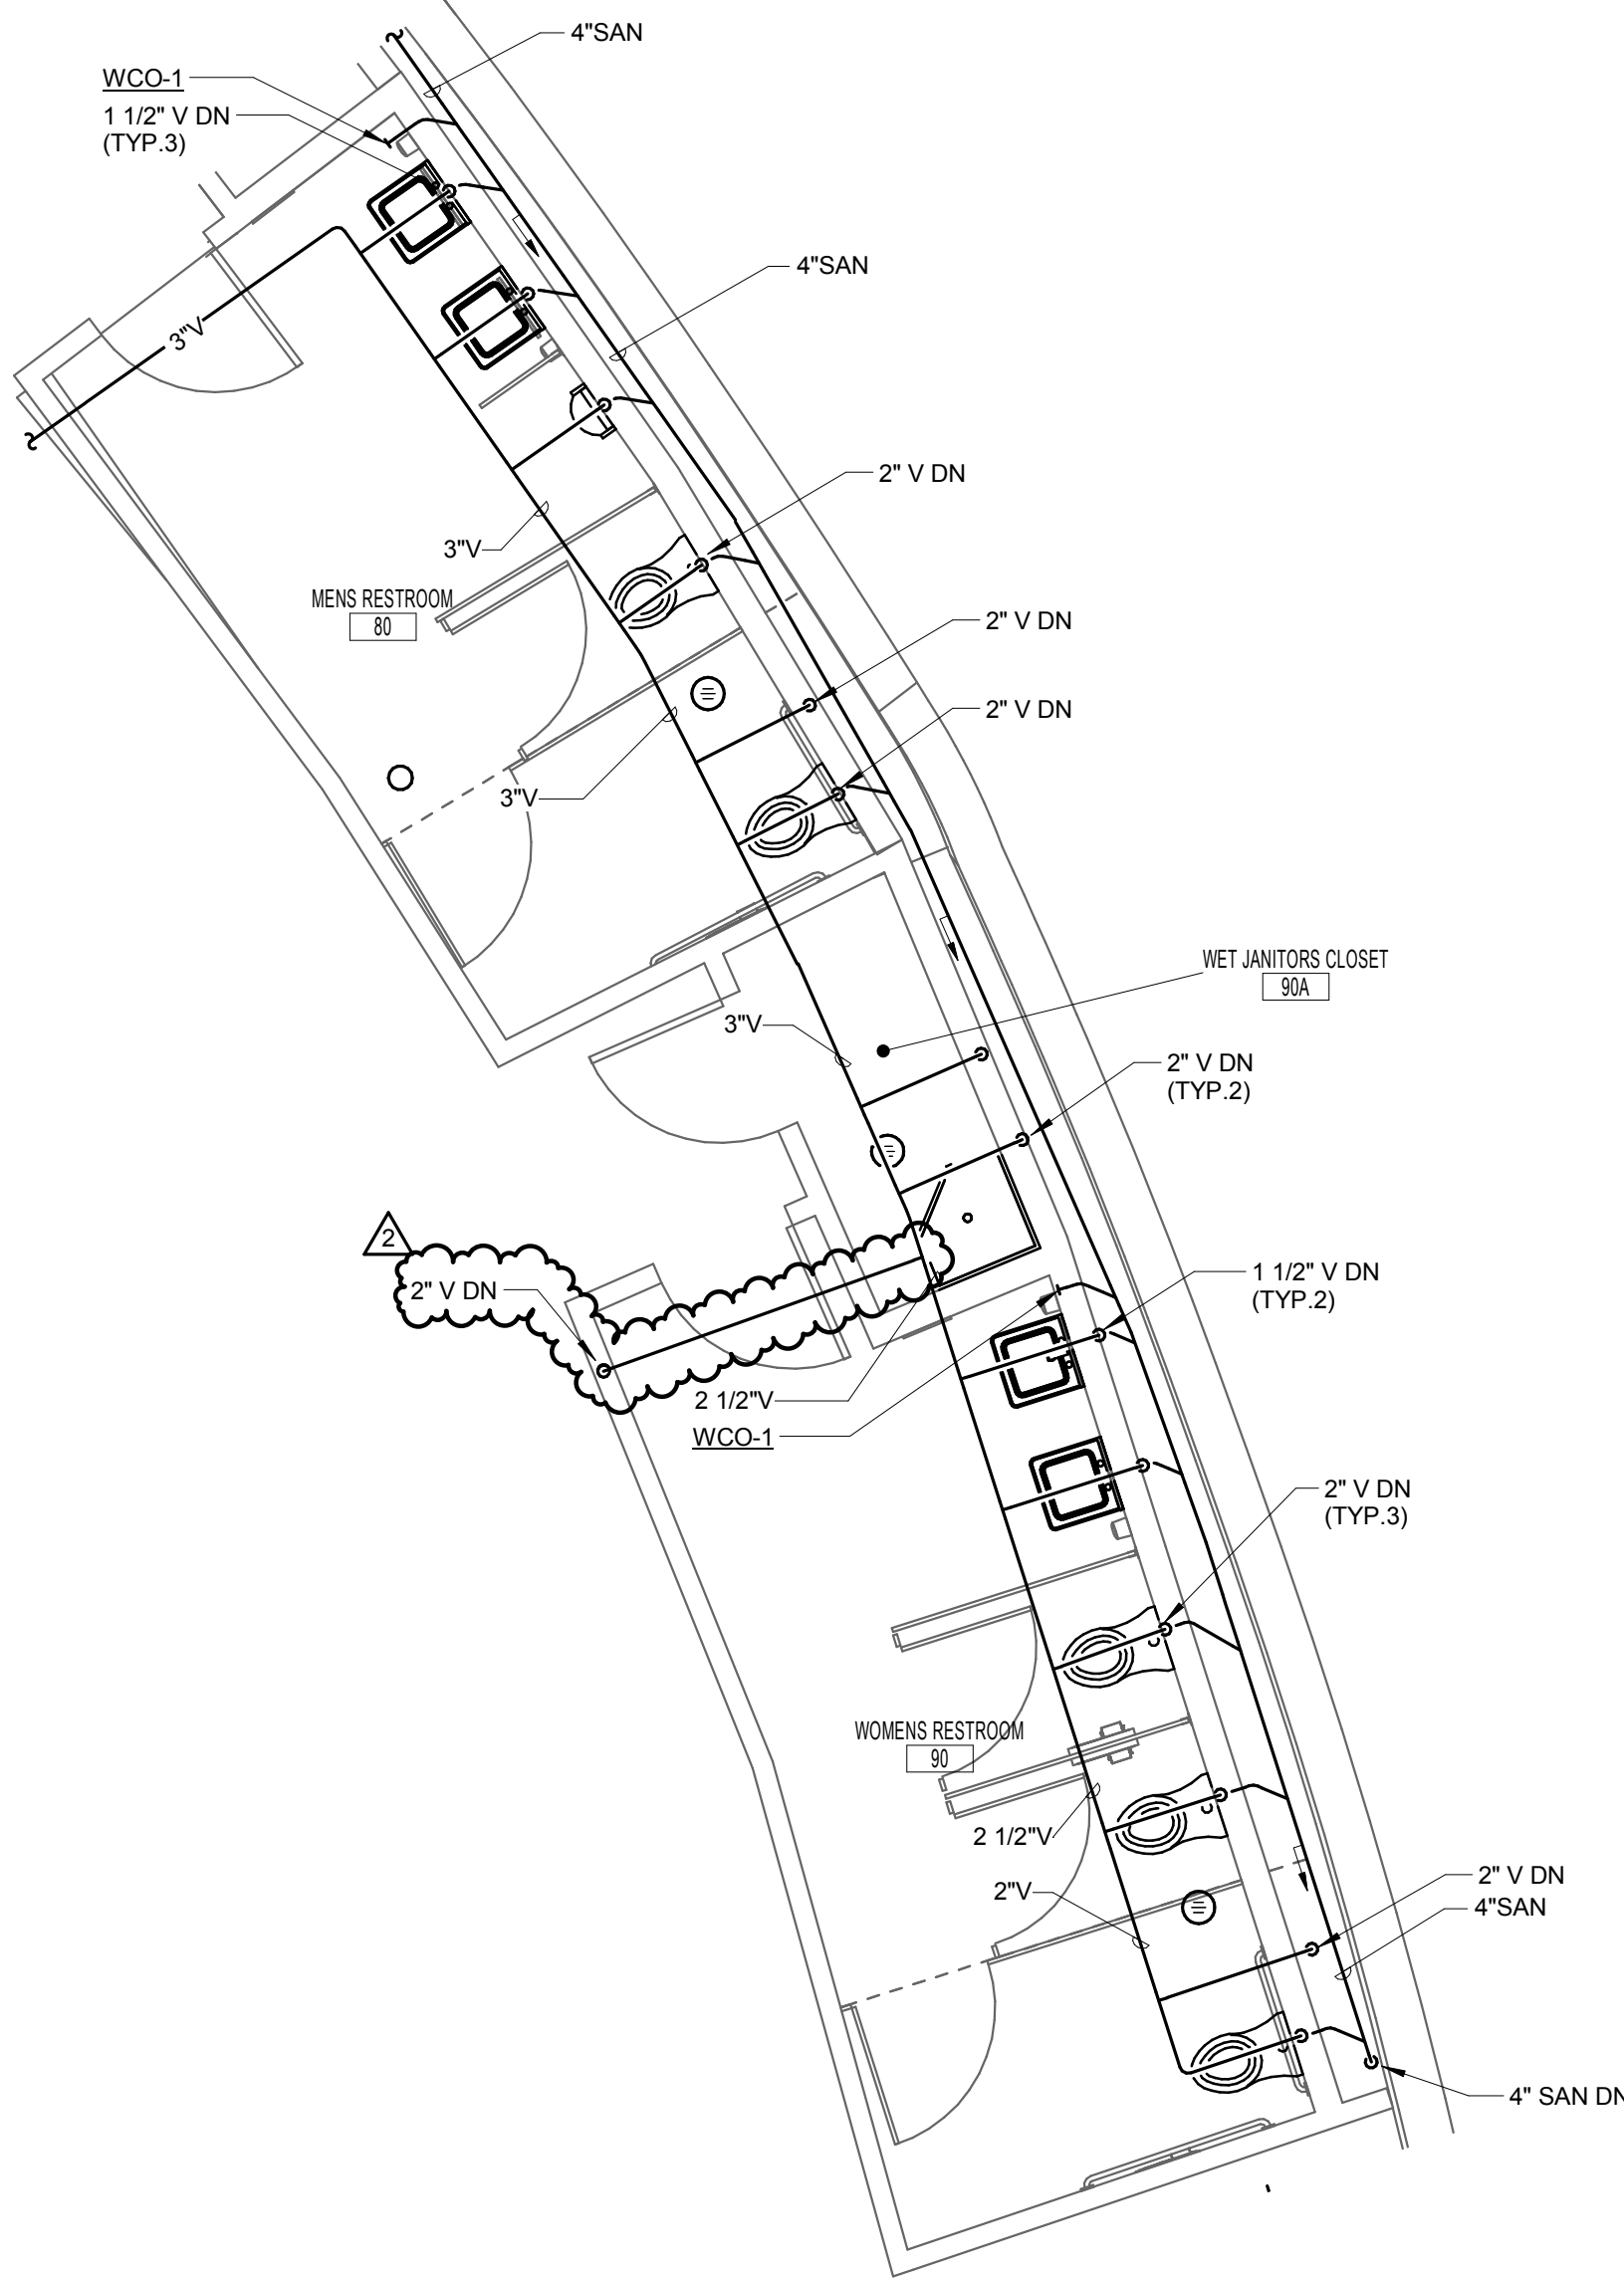

2 ENLARGED PLAN - ACCESS TUNNEL FLOOR - SAN & VENT
1/4" = 1'-0"

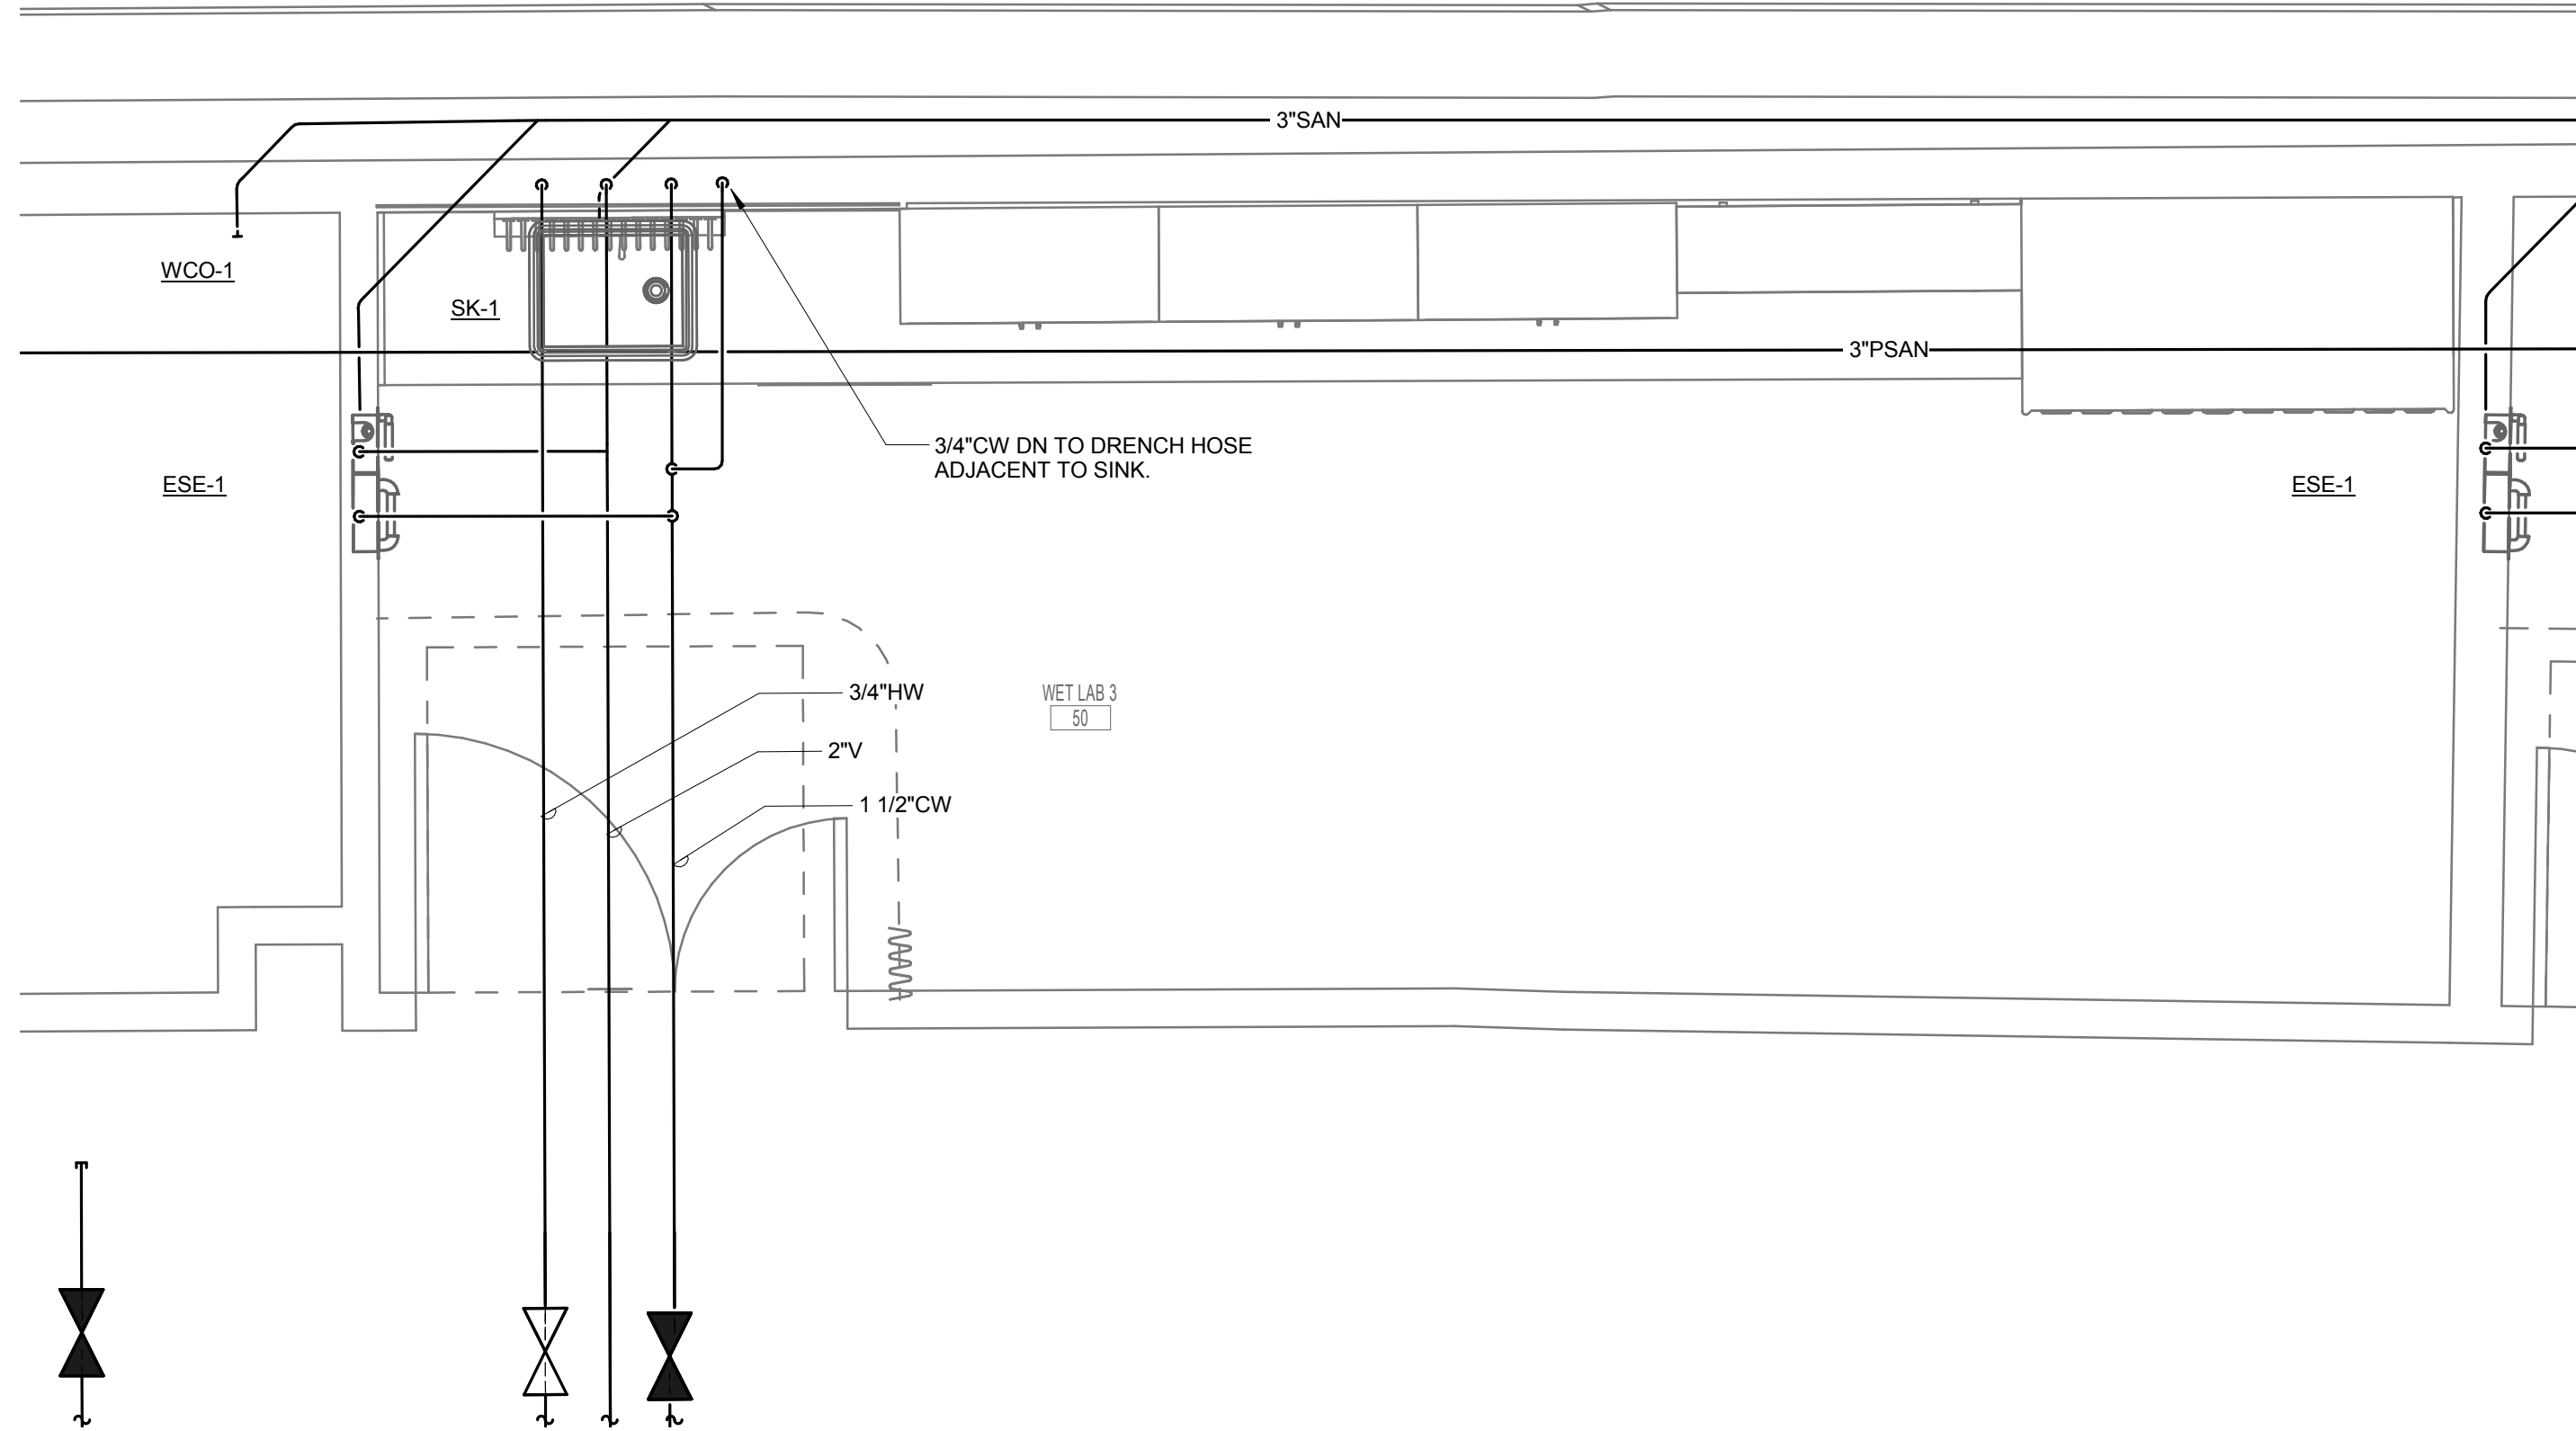

3 ACCESS TUNNEL FLOOR PLAN - PLUMBING - BID OPTION #1
1/2" = 1'-0"

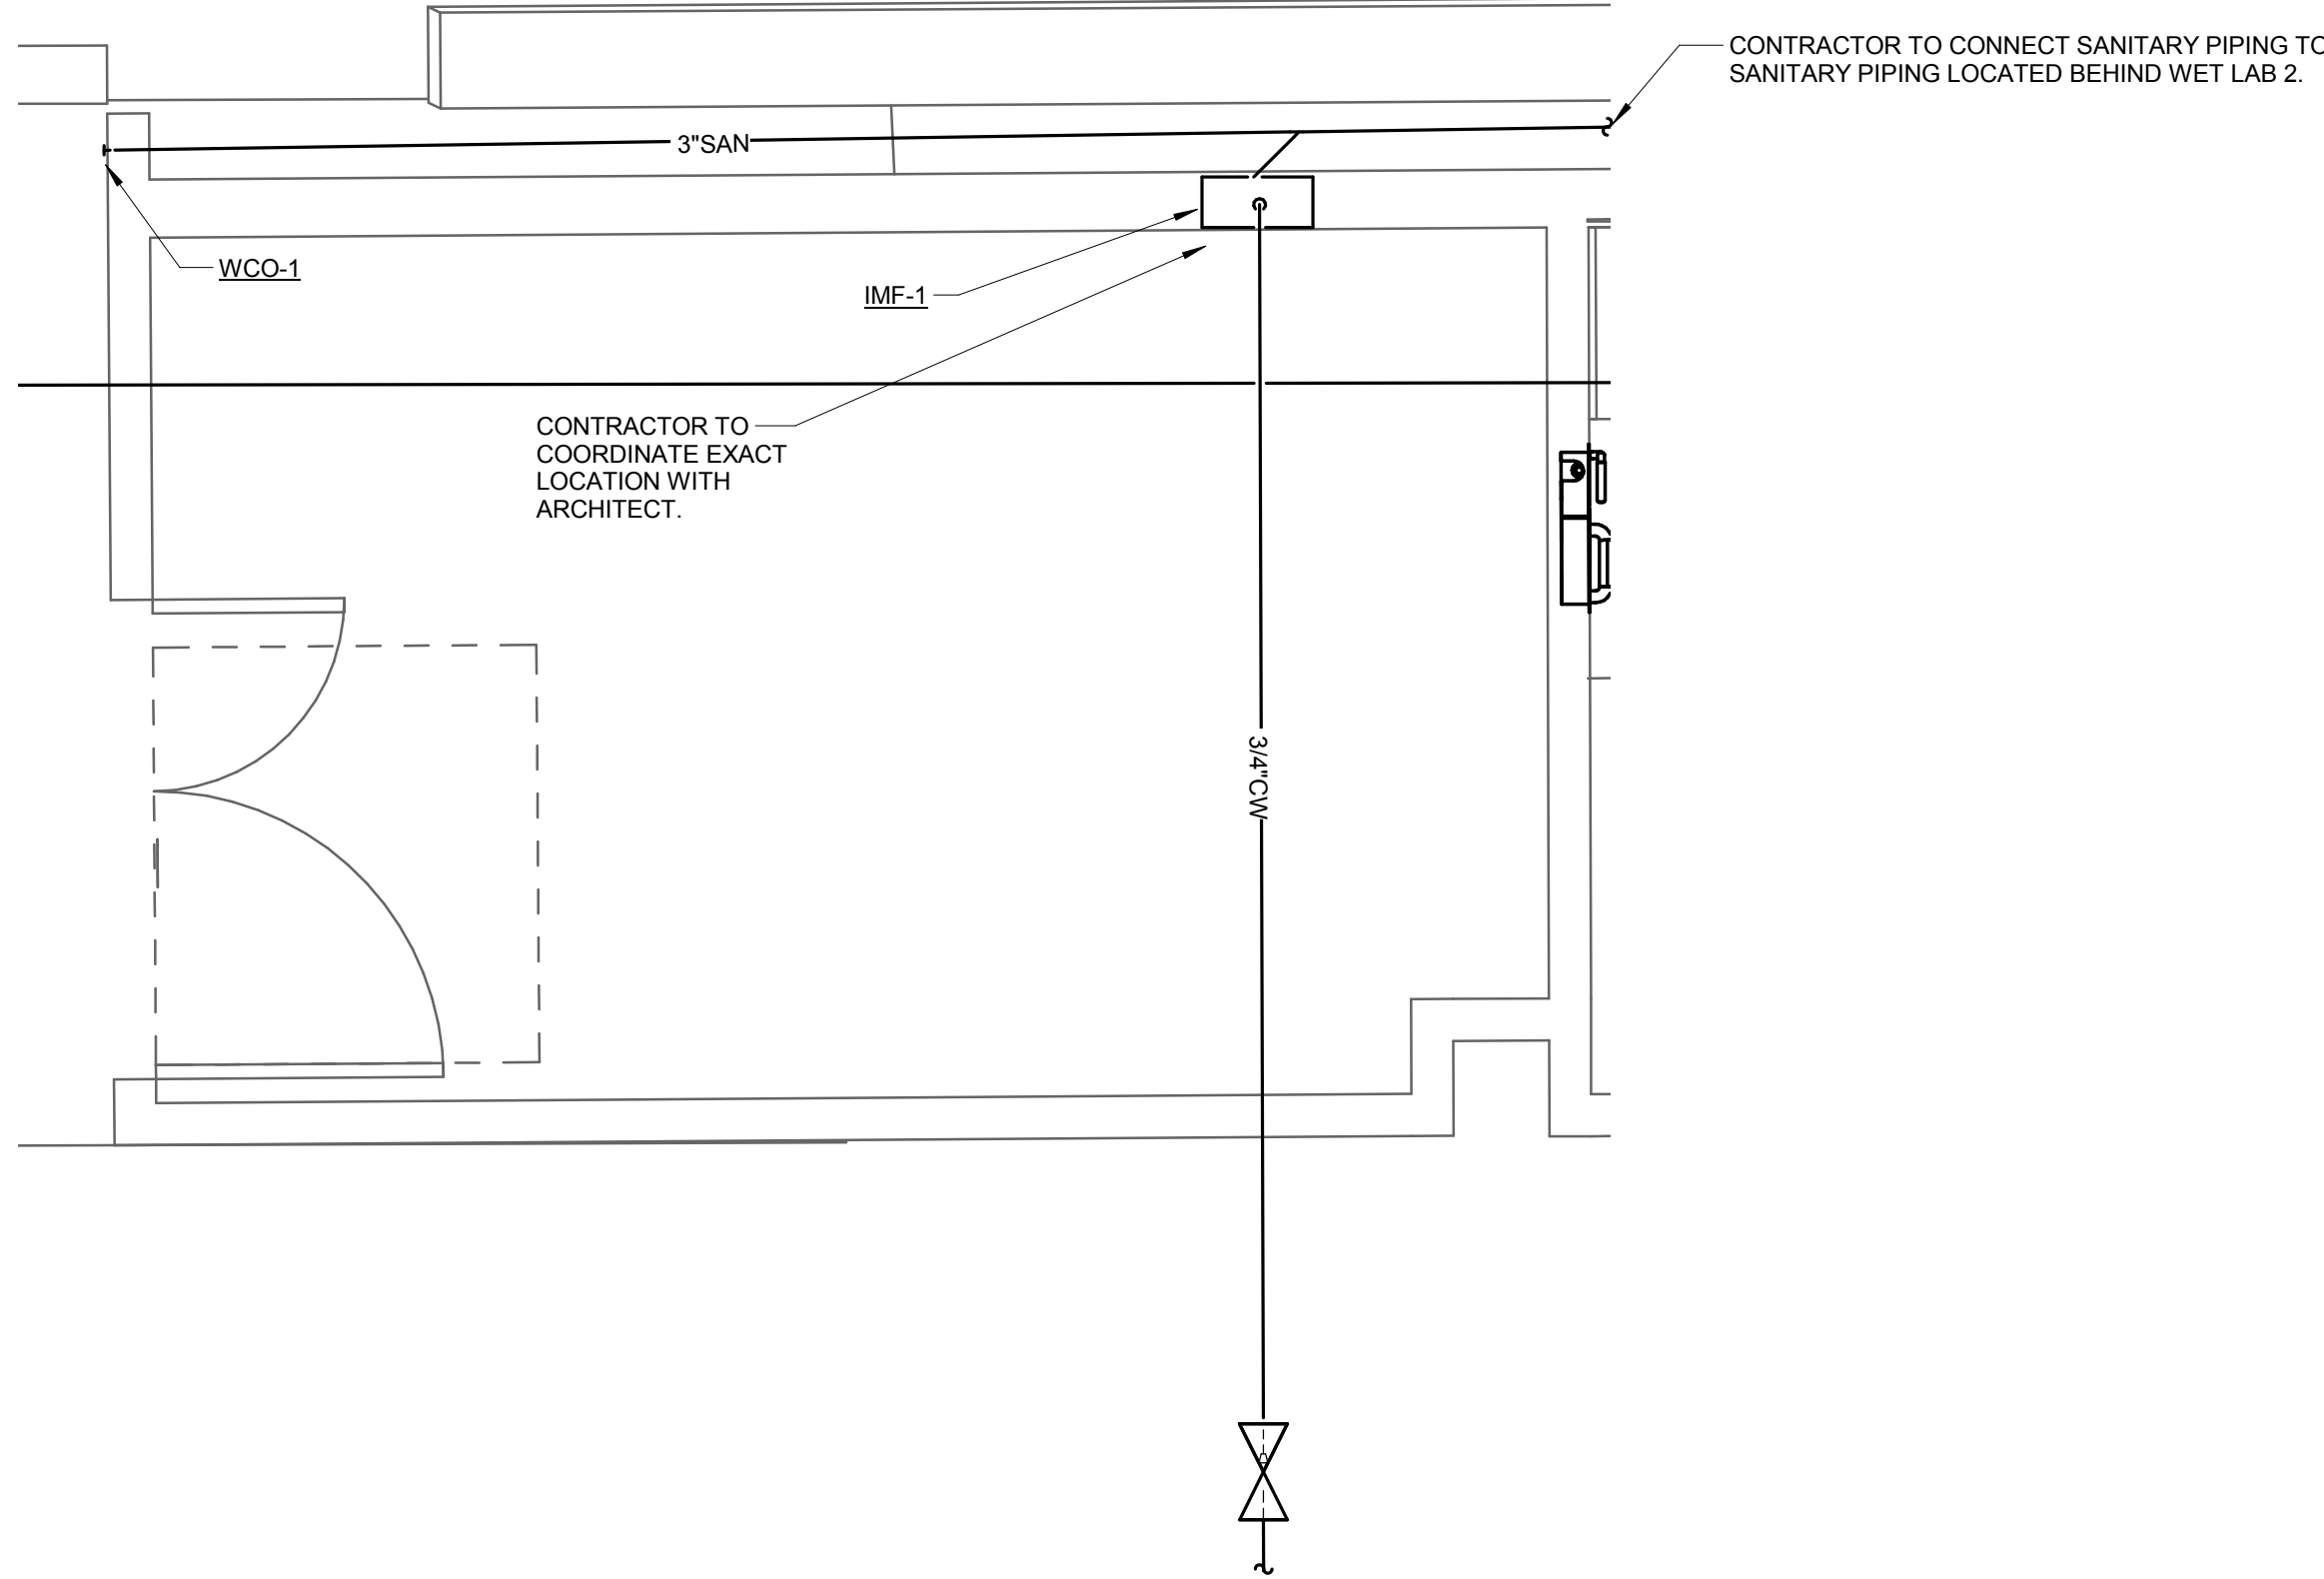

4 ACCESS TUNNEL FLOOR PLAN - PLUMBING - BID OPTION #2
1/2" = 1'-0"



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SCALE: As indicated	DO NOT SCALE DRAWINGS	B999D004-0043.dwg	P200	1 of 1
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ENGR. T. DODAS DES. T. DODAS CHKR. D. HICKMAN	DATE 2/1/2017 2/1/2017 2/1/2017	APPROVALS 01/06/2017	DRAWING NUMBER B999D004-0043	REVISION A0
B999 FEH TUNNEL FACILITIES PLUMBING ENLARGED & BID OPTION PLANS				E